

#### City of Somerville

### **ZONING BOARD OF APPEALS**

City Hall 3rd Floor, 93 Highland Avenue, Somerville MA 02143

**TO:** Zoning Board of Appeals

**FROM:** Planning, Preservation, & Zoning Staff **SUBJECT:** 21 Francesca Avenue, P&Z 23-001

**POSTED:** April 27, 2023

#### RECOMMENDATION: NONE

Staff memos are used to communicate background information, analysis, responses to public comments, review of statutory requirements and other information from Planning, Preservation, & Zoning staff to the Review Board members.

This memo summarizes the Administrative Appeal submitted for 21 Francesca Avenue and provides analysis or feedback as necessary. The application was deemed complete on April 14, 2023, and is scheduled for a public hearing on May 3, 2023. Any Staff recommended findings, conditions, and decisions in this memo are based on the information available prior to any public comment at the scheduled public hearing.

#### **LEGAL NOTICE**

Manuel O. Zepeda and Katherine R. Jong seek an administrative appeal of the Building Official's determination of the building type for the non-principal building located at the rear of the lot.

#### **SUMMARY OF PROPOSAL**

In this Administrative Appeal, the Applicant is challenging the Building Official's classification of the carriage barn sited at the rear of 21 Francesca Avenue as an Outbuilding which is an Accessory Structure building type. Instead, the Applicant contends that the structure is an existing Backyard Cottage building type with some non-conforming features and dimensions. An Accessory Building building type and an Accessory *Structure* building type are two different classifications in the SZO.

#### ADDITIONAL REVIEW NECESSARY

The SZO describes an Administrative Appeal as follows in §15.5.2.a.1:

"An administrative appeal is a petition to rectify a failure to act, denial of a permit, decision made, or enforcement action taken by the Building Official or Director of Planning & Zoning in an administrative development review case when an alleged error or misinterpretation has been made in the enforcement or application of the provisions of this Ordinance."

The Zoning Board of Appeals (ZBA) is the review authority for all Administrative Appeals.

#### **BACKGROUND**

21 Francesca Avenue is located in the Neighborhood Residence (NR) zoning district in the Magoun Square neighborhood. This area is represented by Ward 5 Councilor Beatriz Gómez-Mouakad.

There are two buildings on the lot: a 2  $\frac{1}{2}$  -story Detached House building type that is the Principal Building on the lot, and a 1  $\frac{1}{2}$ -story Outbuilding that is an Accessory Structure building type.

The Applicant has provided a narrative presenting their reasoning for why the carriage barn at 21 Francesca Avenue should be considered an existing, non-conforming Backyard Cottage and not an Outbuilding. Their narrative has been appended to this memo.

<u>Past development efforts</u> Beginning in 2021, the Applicant endeavored to convert the carriage barn into a Backyard Cottage through the Site Plan Approval (SPA) process. The SPA process was the mechanism by which Backyard Cottages could be established in the NR zoning district prior to the SZO being amended in September 2022. The September 2022 amendment to this portion of the SZO Backyard Cottages "by right" in the NR district.

It is important to note that "by right" does not mean that all other provisions of the zoning code such as setbacks, floor plate, roof type, and similar can be disregarded. The term "by-right" does not give *carte blanche* development rights to properties that do not conform to site/building dimensions and other regulations. "By right" here simply means that a Backyard Cottage as a building type is allowed to exist in the NR district without ZBA having to approve their creation through the zoning relief process. A "by right" building meets *all other provisions of the zoning code* and needs no board relief. (see above).

Staff does not disagree that the former SPA process to establish a Backyard Cottage was a lengthy one. It required a pre-submittal meeting, two neighborhood meetings, review by the Urban Design Commission (UDC), review by multiple City departments for Green Score, Mobility (vehicular/bike parking and related regulations), Housing, and Engineering. Several iterations of any proposal were required in order to address feedback from multiple stakeholders, both municipal and public. All of this effort was required prior to submitting an application for a hearing of the ZBA for approval of a Backyard Cottage via Site Plan Approval (SPA).

Once the SZO was amended in September 2022, the Applicant's scheduled ZBA hearing for Site Plan Approval to establish a Backyard Cottage at 21 Francesca Avenue became moot – there was no longer any legal ability for the ZBA to consider Site Plan

Approval for the project. Thus, as a result of the amendment, the Applicant was advised to apply for a building permit through ISD. Advisement to apply for a building permit does not indicate that a proposal is free and clear from zoning regulatory analysis by ISD; ISD is the sole entity empowered to interpret the SZO. This additional ISD analysis led to the Building Official determining that the existing carriage barn on the property was an Outbuilding Accessory Structure building type and not a pre-existing, non-conforming Backyard Cottage.

Despite the lengthy process, and despite the zoning ordinance being amended prior to the Applicant being able to be heard by the ZBA for an SPA, sympathy for an Applicant's past diligent efforts to see a project through to fruition cannot be used as valid reasons to either approve or deny an Administrative Appeal.

The ZBA may only consider the SZO and whether this building does or does not already meet the requirements of a Backyard Cottage in deciding whether or not to uphold or overturn the Building Official's classification of the carriage barn as an Outbuilding type of Accessory Structure.

<u>Proposed plans</u> The Applicant submitted a set of documents showing existing and proposed plans for the lot. Staff has not forwarded the proposed plan set to the ZBA. The Board is not allowed to consider a future development proposal when reviewing an Administrative Appeal of an ISD determination of a building type classification.

The above was set forth in a written opinion by the City Solicitor's Office on October 14, 2021 (attached), regarding what the ZBA may consider in these Administrative Appeal situations. The subject of the Administrative Appeal in the Solicitor's written opinion is also a building type classification issue, the difference being the two building types that are in question: Cottage versus Detached House. Regardless of the building type involved in the Administrative Appeal, the Board may *only* render a decision on the matter that is before it: whether or not ISD erred in its classification of the carriage barn at 21 Francesca Avenue as an Outbuilding. The ZBA may *not* consider future plans for the site in their ruling.

#### Relevant text is as follows:

"...[you] have asked whether the ZBA, in an administrative appeal, may consider the future development of a site in ruling on whether the building inspector properly designated a building as a cottage building rather than a detached house. In my Opinion, the board's decision must be confined to the matter pending before the Board and cannot validly determine matters not pending before the Board..."

#### **ANALYSIS**

Any existing building might present some non-conformities for the building type for which it is currently classified. The Building Official (ISD) must classify any building,

including non-conforming ones, to the closest applicable Building Type category that applies to the on-the-ground conditions. The question at hand is whether ISD erred in categorizing the carriage barn at 21 Francesca Avenue as an Outbuilding rather than a Backyard Cottage.

#### Building type classification and dimensional regulations

The SZO regulates structures as Principal Buildings, Accessory Buildings, or Accessory Structures. There are numerous types of Accessory Structures allowed in the NR zoning district, one of which is an Outbuilding. **Section 10.2.1.p** of the SZO states the following.

#### Outbuilding

A free-standing, fully-enclosed structure used for accessory vehicle parking, a home occupation, or as ancillary space for residential principal use including, but not limited to, a playroom for children. The following standards apply:

- i. Outbuildings must be set back at least twenty (20) feet from any front lot line.
- ii. Where an improved alley is available, vehicular access to the outbuilding must take place from the alley.
- iii. An outbuilding may be up to twelve (12) feet in height.
- iv. An outbuilding must be setback a minimum of three (3) feet from any side or rear lot line unless constructed of fireproof materials.

Of the four Outbuilding criteria above, only *i*, *iii*, and *iv* apply (as there is no alley abutting 21 Francesca Avenue, criterion *ii* above is not applicable).

The carriage barn at 21 Francesca meets criterion i in that it is more than 20 feet from the front lot line.

However, the carriage barn does not meet criterion *iii*, as the existing building is over 12 feet in height. Note that the Applicant's zoning chart states that the building is 10'9" in **story height**, but Outbuilding requirements regulate the **total height** of the building, not story height (see existing plan *elevations*). At 28' 2", the carriage barn is well over the allowed height for an Outbuilding.

With the exception of one side setback, the carriage barn is also in violation of all setback requirements by being less than the minimum required 3 feet from the side and rear property lines.

The carriage barn is not in use as a playroom or other ancillary residential use, nor does it provide space for a home occupation. There may be an area that is or can be used for vehicular parking given the vehicular bay on the left front elevation of the carriage barn. The building is currently compliant with permitted Outbuilding uses.

#### Backyard Cottage

The SZO states the following regarding Backyard Cottages in Section 3 of the SZO

A **Backyard Cottage** is "[a] small floor plate, detached, accessory building type typically providing space for one (1) small dwelling unit, a home occupation, a playhouse for children, or vehicular parking on the same lot as a principal building type.

A more specific set of dimensional requirements are set forth in the SZO for a Backyard Cottage building type than for an Outbuilding, including lot width, depth, driveway location dependencies, parking setbacks, front, side, and rear setbacks, along with number of stories, story height, etc.

**Sections 3.1.12.a** and 3.1.12.c of the SZO provide the regulatory dimensions for Backyard Cottages. Of all the criteria, the existing carriage barn does not meet the following regulatory requirements for a Backyard Cottage:

Dimension	Required	Existing
Side Setback (left)	3.0'	1' 10"
Rear Setback	3.0'	1' 8"
10-foot Building Separation	10.0'	7' 1"
(from carriage barn to garage on		
17-19 Francesca)		
Maximum Building Width	24.0'	42' 5"
Maximum Floor Plate	576 sf	975 sf
Roof Type	Gable or Flat	Hip
		(this is not a "gable" roof as stated in the Applicant's zoning chart)
		there is a small dormer with a gable
		roof – this does not count toward
		the roof type. The main roof is a Hip
		roof which is not a form that is
		permitted.

Building types are defined by their combined disposition, configuration, and function and are differentiated from each other by *dimensional standards* (see above), customized for each building type. Each building type permitted within a zoning district is presented in detail in the SZO.

To properly administer a building type-based zoning ordinance like Somerville's, the Superintendent of Inspectional Services ('Building Official') must determine which building type is the appropriate classification for every existing structure in Somerville. All of the building type descriptions, standards, dimensions and other related provisions are taken into consideration in addition to the purpose of the zoning district when classifying an existing structure. Structures are not classified in isolation, but in consideration of multiple standards.

The Building Official must also classify existing uses as falling within either one of the permitted categories of uses, or the specific existing use is determined to be a non-conforming pre-existing use. The classification of existing uses is common to the administration of all zoning ordinances. The classification of existing structures is necessary for any ordinance that differentiates between the class (type) of structures it regulates, such as Somerville's.

#### **CONSIDERATIONS & FINDINGS**

If the Board finds that the existing conditions regarding the carriage barn at 21 Francesca Avenue reflect an Outbuilding Accessory Structure building type, the Board should deny the Administrative Appeal and uphold ISD's determination.

If the Board finds that the existing conditions regarding the carriage barn at 21 Francesca Avenue reflect a Backyard Cottage building type, the Board should approve the Administrative Appeal and overturn ISD's determination.

Subject: RE: Scope of matters before the ZBA

Date: Wednesday, October 13, 2021 at 2:44:41 PM Eastern Daylight Time

From: David Shapiro
To: Daniel Bartman

**CC:** Susan Tkaczuk, Francis Wright

Dan,

You have asked whether the ZBA, in an administrative appeal, may consider the future development of a site in ruling on whether the building inspector properly designated a building as a cottage building rather than a detached house. In my opinion, the board's decision must be confined to the matter pending before the Board and cannot validly determine matters not pending before the Board. See, Dion v. Board of Appeals of Waltham, 344 Mass. 547, 554 (1962).

Please let me know if you have any additional questions.

#### **David Shapiro**

David Shapiro
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#### **City of Somerville Public Records Notice**

Please be advised that the Massachusetts Attorney General has determined that email is a public record unless the content of the email falls within one of the stated exemptions under the Massachusetts Public Records Laws.

# ADMINISTRATIVE APPEAL DEVELOPMENT NARRATIVE

**Property:** 21-23 Francesca Avenue

**Applicants and Owners/Appellants:** 

Manuel O. Zepeda, Trustee of the Manuel O. Zepeda Revocable Trust and Katherine R. Jong, Trustee of the Katherine R. Jong

Revocable Trust

**Agent:** Adam Dash, Esq.

**Zoning District:** NR (1/2 mile Transit Area/Not in a Pedestrian Street District)

#### Background.

The property at 21-23 Francesca Avenue (the "Property") currently contains a pre-existing, nonconforming two-family house with a pre-existing, non-conforming carriage house in the rear of the lot. Applicants/Owners/Appellants Manuel O. Zepeda, Trustee of the Manuel O. Zepeda Revocable Trust and Katherine R. Jong, Trustee of the Katherine R. Jong Revocable Trust ("Applicants"), reside in the neighborhood and wish to have more space for their family.

Applicant asserts that the existing carriage house structure in question is already a pre-existing Backyard Cottage building type and, as such, is grandfathered as to any existing dimensional nonconformities. It has been in its current state and location for a very, very long time and Applicants do not propose to dimensionally change it, such that Applicant's filing for a building permit to renovate it so as to make it into one dwelling unit should be granted by right. The existing two-family house would be changed into a single-family house, also by right.

In the alternative, should the pre-existing, nonconforming structure not be found to already be a Backyard Cottage building type, Applicants argue that they propose to renovate the existing rear carriage house and to convert it into one dwelling unit as a Backyard Cottage, while converting the existing two-family house into a single-family house.

If the Applicants' proposed project is granted a building permit, there would still only be two dwelling units at the Property, but one will be in the main house, and one will be in the Backyard Cottage.

Applicants would make alterations to both the existing main house and the existing carriage house to carry out the proposal, as shown on the plans filed herewith. None of the pre-existing nonconformities would be increased, and no new nonconformities would be created.

#### Administrative Appeal Summary.

In accordance with Somerville Zoning Ordinance ("SZO") 15.5.2, Applicants hereby appeal the administrative decision of Inspectional Services Division dated December 16, 2022, a copy of which is attached as Exhibit A, that the conversion of the existing carriage house at the Property into a Backyard Cottage would require redesigning and altering said pre-existing, nonconforming structure to meet the requirements for a Backyard Cottage to address dimensions which do not

meet the Backyard Cottage requirements, including but not limited to side and rear setbacks, building width, max floor plate, and roof type.

While it makes sense that new construction of Backyard Cottage building types would have to comply with that building type's dimensional requirements, it is not feasible for pre-existing, nonconforming structures as in this case to comply without destroying their character or entire existence, such that such grandfathering of dimensions needs to be permitted in order to carry out the purpose of the Somerville Zoning Ordinance and the City's SomerVision 2040 strategic plan.

Said decision being appealed states that the Applicants can argue that the existing structure in question already is a Backyard Cottage such that abuilding permit can be issued by right, and Applicants hereby make said argument. In the alternative, Applicants argue that they can convert the existing structure in question into a Backyard Cottage by right. Either way, the project being proposed by Applicants ends up the same.

#### **Procedural History of this Project.**

Applicants have been trying to convert the carriage house at the Property into living space for about two years now, however, Applicants' efforts have been repeatedly frustrated.

Applicants first reached out to the City's Preservation, Planning & Zoning Division ("PP&Z") back in December 2020 about said project. After some back and forth, PP&Z replied on March 2, 2021 that converting the carriage house into a Backyard Cottage could be done, but would require Site Plan Approval.

On March 22, 2021, Applicants filed for a Certificate of Zoning Compliance ("CZC") to "[c]onvert a carriage house into one backyard cottage unit, and convert the existing two family house into a single unit", which was Case #CZC 21-000094.

After a significant delay in receiving a response to said CZC application, in July 2021 the matter was given the Case #P&Z 21-031, and a Pre-Submittal Meeting was held regarding same on August 24, 2021.

During that Pre-Submittal Meeting, the project was thoroughly discussed with representatives of City departments. Applicants made clear that they wished to preserve the pre-existing carriage house and were not going to add or take away space from it. Even the small horse stall window openings were being retained. Applicants were told that the project needed Site Plan Approval and that there would need to be a neighborhood meeting, then the matter would go to the Urban Design Commission ("UDC"), then a second neighborhood meeting, then the Development Review Application ("DRA") could be filed, and the matter would go to the Zoning Board of Appeals ("ZBA"). Applicants were told that, as a pre-existing, nonconforming structure, the carriage house could stay since it was an allowed building type in the NR zoning district as a Backyard Cottage.

A first neighborhood meeting was held on November 30, 2021. There was no opposition to the project, and neighbors expressed their support for the project.

Applicants then went before the UDC on March 8, 2022. The UCD voted to accept the project as presented and provided no comments.

A second neighborhood meeting was held on March 30, 2022. There was no opposition to the project, and neighbors expressed their support for the project.

On June 24, 2022, Applicants filed the DRA for the Site Plan Approval of the project, per SZO 3.1.6.d, seeking Site Plan Approval for a Backyard Cottage in the NR zoning district. The Site Plan Approval was only for the Backyard Cottage, and not for the main house at the Property, because the modifications to the main house were by right. The Development Narrative and Plans filed with said DRA are attached hereto as Exhibit B.

As a Backyard Cottage is a permitted Building Type in the NR district, and as the pre-existing, nonconforming structure would not be modified so as to create any new nonconformity or to increase any existing nonconformity, then per SZO 14.1.5.c.ii, no Special Permit was required for the project.

As stated in Applicants' DRA Development Narrative, the project would comply with the City's objectives, including the preservation of historical resources such as the existing carriage house, and will allow families to remain in the City as they grow. This would be done without adding any dwelling units to the Property, such that the Property would still contain only two dwelling units, in compliance with the purpose of the NR zoning district. The contextual modifications being proposed would fit within the purpose of the NR zoning district by allowing the existing structures and number of dwelling units to remain. Without this Site Plan Approval, the carriage house, in its poor condition, would likely not remain. The Backyard Cottage would be minimally seen from the public way; and, to the neighbors, the existing structures on the Property would remain, but in an improved state.

Applicants then waited for a date to appear before the ZBA. After a long wait, Applicants' Site Plan Approval application was placed on the ZBA's agenda for September 21, 2022, a copy of which is attached hereto as Exhibit C.

On September 8, 2022, the City Council approved an amendment to the SZO which made Backyard Cottage building types by right in the NR zoning district. Applicants were then told by PP&Z that Applicants no longer needed Site Plan Approval and that their matter was being removed from the ZBA's September 21, 2022 agenda since it was now by right.

Applicants then filed for a building permit to convert the carriage house into living space by right, which was given the number B 22-001679. The plan set filed for the building permit is attached hereto as Exhibit D.

On December 16, 2022, Applicants' building permit application was denied because "[c]onversion of the existing outbuilding into a backyard cottage would necessitate compliance

with all requirements of SZO 3.1.12. Currently, the design does not meet many of these requirements, including but not limited to side and rear setbacks, building width, max floor plate, and roof type. Please redesign or seek relief. You may also appeal the determination that the existing structure is not an outbuilding but is actually an existing backyard cottage. This appeal can be done in accordance with SZO 15.5.2 -Administrative Appeal". The denial also asked Applicants to provide some additional information, which is contained in the plan set attached hereto as Exhibit E.

Applicants now seek an Administrative Appeal of said denial.

#### Argument.

It is Applicants' position that the pre-existing, nonconforming carriage house structure is grandfathered as to all dimensional nonconformities, being a long-standing, pre-existing building. Whether it is already a Backyard Cottage, or whether it has to be converted into a Backyard Cottage, the rationale is the same. The structure in question is pre-existing and dimensionally nonconforming, and its dimensions will not change. All that will change is that it will become a dwelling unit and be restored to allow for such use. Being an allowed building type in the NR zoning district, a Backyard Cottage is by right, and Applicants should be granted a by right building permit to carry out their project.

It is also Applicants' position that they had been told the project required Site Plan Approval, and then told that it was by right, after about two years of public process. The City cannot now contradict its prior findings after Applicants have spent so much time and money on drawings and legal fees in reliance on the City's determinations.

#### a. Purpose.

Having to so substantially alter the carriage house as suggested in the building permit denial would cause it to lose its current, historical appearance, which Applicants were trying to preserve by keeping the structure and using it as living space. Preserving these kinds of outbuildings from demolition was the purpose of allowing them to be converted into Backyard Cottages in the first place. If all such carriage houses have to comply with all of the dimensional requirements of the Backyard Cottage building type, then many of the more significant carriage houses will have to be demolished or heavily altered, which runs counter to the creation of said building type's purpose.

While it makes sense that new construction of Backyard Cottage building types would have to comply with that building type's dimensional requirements, it is not feasible for pre-existing, nonconforming structures, as in this case, to comply without destroying their character or entire existence, such that such grandfathering of dimensions needs to be permitted in order to carry out the purpose of the Somerville Zoning Ordinance and the City's SomerVision 2040 strategic plan. This is especially true of the recent SZO amendment to make Backyard Cottages by right in the

NR zoning district, which would not be possible if the reasons for the denial of Applicants' building permit are upheld.

Per SZO 3.1.12, a Backyard Cottage building type is:

A small floor plate, detached, accessory building type typically providing space for one (1) small dwelling unit, a home occupation, a playhouse for children, or vehicular parking on the same lot as a principal building type

Being a carriage house, the structure in question has been used for vehicular parking for a very, very long time. As such, being a small floor plate, detached, accessory building used for parking on the same lot as a principal building type, it is a Backyard Cottage already. In fact, there is no other building type in the SZO which is otherwise could be. It may be a pre-existing, dimensionally nonconforming Backyard Cottage, but it is a Backyard Cottage building type nonetheless.

Most structures in Somerville are pre-existing and dimensionally nonconforming as to their respective building type under the SZO, but they are grandfathered in that respect, as is the Applicants' carriage house.

Per SZO 1.1.4.d.v, the intent of the SZO is, in part:

To preserve and enhance the existing character of Somerville's traditional housing and respect existing built form and development patterns.

Per SZO 3.3.e, one of the purposes of the Neighborhood Residence ("NR") zoning district, in which this property is located, is:

To create dwelling unit types, sizes, and bedroom counts ideal for smaller households in cottages and backyard cottages.

The SomerVision 2040 strategic plan also supports Applicants' Administrative Appeal, as follows:

The SomerVision 2040 Map illustrates our vision for the community to conserve our great residential neighborhoods, enhance our funky square and commercial corridors, and transform opportunity areas on the eastern and southern edges of Somerville.

The NR zoning district is described as a residential neighborhood to conserve, which would include allowing the Applicants' carriage house to be kept from demolition by allowing it to be used as a dwelling unit.

SomerVision 2040's goals regarding climate and sustainability can be met by retaining existing structures, rather than razing them and then building new structures, thereby wasting building materials while squandering the embedded energy from contructing and maintaining such pre-existing structures. To quote various portions of SomerVision 2040:

We need to integrate sustainability in all City processes, especially the way we live and move about.

Our infrastructure plays a critical role in improving our sustainability and resiliency to future climate events. We should explore traditional and innovative ways of addressing our problems.

Evaluate waste streams including trash, recycling, and organic waste.

Our housing stock needs to be ready for the 21st century—low energy, resilient, healthy, and comfortable. To meet these goals, the majority of the houses in Somerville need significant renovations. Therefore, this goal needs thoughtful consideration to avoid the negative impacts associated with gut renovations.

The best way to achieve these goals is to allow property owners to adapt their existing structures for productive uses. Applicants are only seeking to do that with their carriage house by making it living space.

#### b. Nonconformity.

Per <u>Blasco v. Board of Appeals of Winchendon</u>, 31 Mass. App. Ct. 32 (1991), nonconforming structures can be altered to provide for a substantially different purpose only where a local zoning ordinance authorizes this practice. Municipalities are free to liberally allow or prohibit such changes.

In the case of Somerville, such changes are permitted by the SZO.

Per SZO 14.1.5.c:

Modifications.

Any modification to a permitted principal building type, building component, or accessory building type that is nonconforming to any standard for that specific principal building type, building component or accessory building type is permitted, subject to the following:

- a). The creation of any new nonconformity is prohibited.
- b). Any increase in an existing nonconformity is prohibited.

#### Per SZO 14.1.5.d:

Accessory Structures
i. Any modification that increases an existing
nonconformity or creates a new nonconformity is
prohibited.

ii. Any modification that results in greater conformance to this Ordinance is permitted.

The Applicants' project does not increase an existing nonconformity, nor does it create a new nonconformity. In fact, by already being a Backyard Cottage building type, or by converting the carriage house into a Backyard Cottage building type, Applicants' is dealing with an allowed building type in the NR zoning district which is dimensionally grandfathered. As such, Applicants' proposal is by right, per the SZO.

Forcing property owners with pre-existing, dimensionally nonconforming structures to obtain zoning relief to renovate and use said structures goes against the very words of SZO Section 14.1.5, the intent of which is to allow such structures to be modified provided, as in the Applicants' case, no nonconformity is being increased or created.

#### c. Historic Preservation.

Another issue is that the substantial alterations being required to obtain a building permit, per the decision being appealed, would run afoul of the City's Demolition Review Ordinance, being Ordinance number 20-20, which seeks to preserve significant structures by imposing an 18 month delay on their demolition so that property owners can find alternatives to demolition, which definition includes removing more than 50% of the building's external surface area.

Forcing Applicants to substantially alter, rather than preserve, an historic structure such as the carriage house at the Property runs counter to the purpose of the Demolition Review Ordinance, in addition to the purposes of the Somerville Zoning Ordinance and the intent of SomerVision 2040.

#### Conclusion.

Applicants have been run around for the past two years for simply trying to do the right thing. They have done what the City asked them to do along the way, but they desire and need to move this project along.

Applicants simply want to preserve their carriage house, either as a pre-existing, nonconforming Backyard Cottage building type, or by converting it into a Backyard Cottage building type. They do not seek to add units to their Property. They do not seek to enlarge the carriage house. They do not seek to demolish the carriage house and build a new structure.

In attempting to do this simple thing, they attempted to obtain Site Plan Approval and, then when the City amended the SZO to make Backyard Cottages by right in the NR zoning district, they tried to get a building permit. Now, they are being told to substantially alter the pre-existing, nonconforming structure in order to obtain a building permit, which Applicants never wanted to do, as they wanted to retain the historic character of the carriage house.

The decision being administratively appealed here prevents the intent of the SZO, SomerVision 2040, and the Demolition Review Ordinance from being realized.

Applicants respectfully request that said December 16, 2022 decision be overturned and that they be given a by right building permit to convert the carriage house at the Property into living space in a Backyard Cottage building type.

Manuel O. Zepeda, Trustee of the Manuel O. Zepeda Revocable
Trust and Katherine R. Jong, Trustee of the
Katherine R. Jong
Revocable Trust, Appellants
By their attorney

Adam Dash, Esq. BBO#557239 Adam Dash & Associates 48 Grove Street, Suite 304

Somerville, MA 02144 617-625-7373

dash@adamdashlaw.com

Date: January 3, 2023

#### Application Review Comments

msarcione@somervillema.gov <msarcione@somervillema.gov>

Fri 12/16/2022 11:13 AM

To: penze@hotmail.com <penze@hotmail.com>;Adam Dash <dash@adamdashlaw.com>

Cc: nantanavica@somervillema.gov < nantanavica@somervillema.gov >

Please see updated comment #1 below with information regarding appealing the classification of the existing structure. If you still wish to meet to discuss this project, please let us know.

FROM: Matt Sarcione,

DATE: December 16, 2022

RE: Building Permit Application Review Comments for B22-001679; 21 FRANCESCA AVE , SOMERVILLE, MA 02144

The following comments are relative to your application for Building Permit.

Reviewer: Matt Sarcione, Planning and Zoning

Review Status: Resubmittal Required

- 1. The existing structure has been determined to be an outbuilding as described in SZO 10.2.2.p. Conversion of the existing outbuilding into a backyard cottage would necessitate compliance with all requirements of SZO 3.1.12. Currently, the design does not meet many of these requirements, including but not limited to side and rear setbacks, building width, max floor plate, and roof type. Please redesign or seek relief. You may also appeal the determination that the existing structure is not an outbuilding but is actually an existing backyard cottage. This appeal can be done in accordance with SZO 15.5.2 -Administrative Appeal.
- 2. Please confirm dimensions of proposed front porch. The porch will need to meet the requirements of a either a stoop, portico, or porch from SZO 3.1.13.
- 3. Provide dimensions for the proposed front entry canopy to ensure compliance with SZO 3.1.13.e
- 4. Provide the distance between the proposed front porch and the rear corner of the principle dwelling on the property.
- 5. Provide the maximum ceiling height in the half story and the height above the finished floor of the halfstory where the roof rafters intersect the wall plate or top of wall frame of the exterior walls to ensure compliance with SZO 2.4.4.a.viii.b
- 6. Per SZO 3.1.12.d, Utility services for the Backyard Cottage must be buried underground.

#### Please do not reply to this email. All resubmittals should be done using our online portal.

Please contact me with ary questions you may have, I can be reached at or by email msarcione@somervillema.gov

Sincerely, Matt Sarcione




# SOMERVILLE, MASSACHUSETTS 02144 21-23 FRANCESCA PROPOSED TWO-FAMILY RENOVATION AVENUE

Lot Dimensions	Required	Provided	
Lot Width (front driveway access)	34 ft	50 ft (existing)	conforming
LOI Debits	80 ft	101.52 ft (existing)	conforming
Lot Development			
I of County (maximum)	*	1,305 SF (existing)	
Green Score	0.35 minimum	0.352	conforming
Building Setbacks			2
Primary Front Setback (min/max) Side Setbacks (front driveway access)	10 ft - 20 ft	12'-6" (existing)	conforming
and an arrange worked		Z-O" was I (driveway) side	conforming
Sum of Side Setbacks (min)		15'-6" (existing)	conforming
Rear Settack (min) Main House Building Separation (min)		34'-4" (existing)	conforming
Main house to 25-27 Francesca	1011	21-8"	conforming
Single Division in the Control of th			Comomon
Width (minimax)	22 ft - 28 ft	49%	existing non-conforming
Depth (min/max)	28 ft - 48 ft	47-1"	conforming
Story Height (min/max)	211	3-5	conforming
Number of Stories (max)	2.5	2-5 (181), 9-6 (2nd)	conforming
Façade Composition			
Upper Story Fenestration (min/max)	15%-50%	16%	conforming
Ise & Occupancy			
Dwelling Units per Lot (max)	3	2	conforming
Outdoor Amenity Space (min)	1/00	2	conforming
Required ADUs			
0-2 Dwelling Units	0	0	conforming
Parking			
Motor Vehicle Parking	none	0	conforming
	within 1/2 mile Transit Area	2	conforming
Existing Carriage House/Barn 3.1.12 Backyard Cottage			
of Dimensions	Required	Provided	
Lot Width (front driveway access)			
Lot Depth	80 ft	101.52 ft (existing)	conforming
at Development			
Lot Coverage (maximum)			conforming
agai ocora	0.35 minimum	to be calculated	
Building Setbacks			
		1'-10" east	conforming existing non-conforming
			conforming
Rear Setback (min) Main House Building Separation (min)	3ft	1'-8"	existing non-conforming
ain house to Carriage House	10 ft		onforming
Carriage House to 17-19 Gerage		7-1"	existing non-conforming
ain Massing			
Width (max)			asting non-conforming
axi	32 ft	24:-5"	conforming
Story Height (max)			existing non-conforming
Stories (max)			conforming
Roof Type	t, Gable	Geble/Hip with Cupola o	conforming
gade Composition			
Ground Story Fenestration Residential Use (min/max) Ground Story Fenestration Vehicular Parking (min/max)			conforming
	15%-50%	NA C	contorning
se & Occupancy			
Dwelling Units per Lot (max)  Dwelling Units (max)	3 2		conforming
			Company

780 CMR 9th Edition - 2015 ICC with BUILDING CODE ANALYSIS:

s, habitable attics, and every sleeping room shall one operable emergency escape and rescue



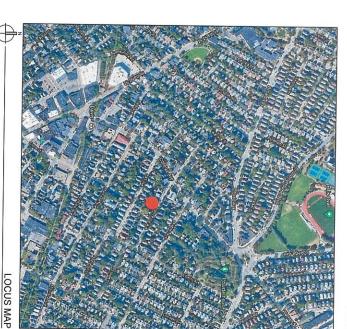



NOT TO SCALE 06.13.2022 T-100



FROPOSED ZONING ANALYSIS, LCCUS, & MASSING PROPOSED TWO-FAMILY RENOVATION ZEPEDA & JONG RESIDENCE 21-23 FRANCESCA AVE. SCMERVILLE, MA 02144

20 Windom Street Somerville Messach (617) 006-9222 (817) 006-9222

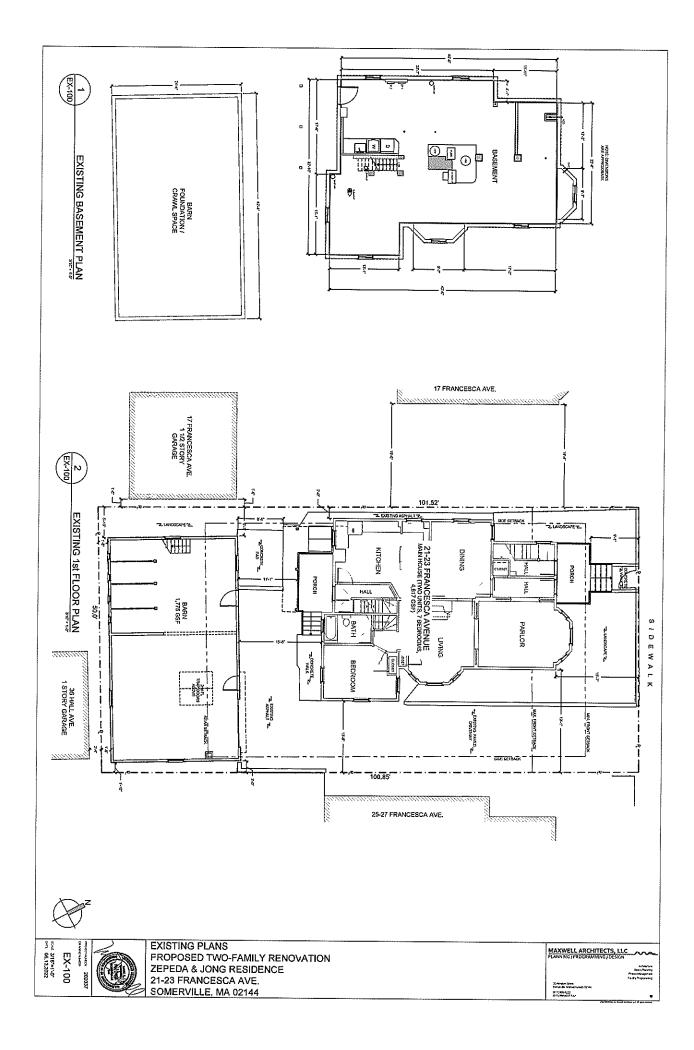

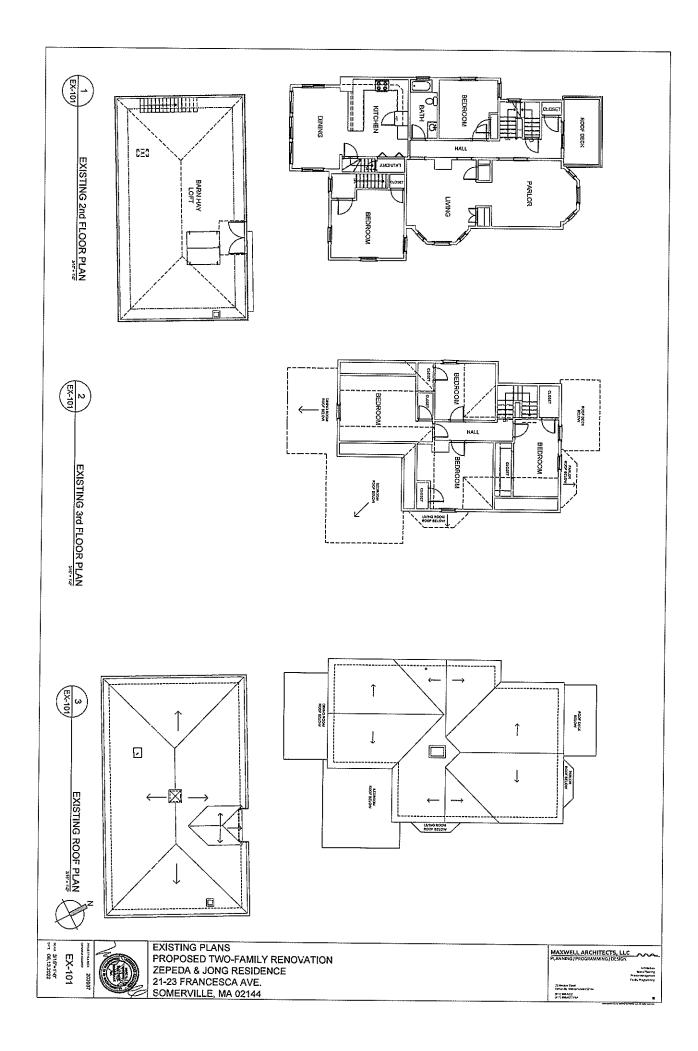




SOMERVILLE, MA 02144



ZEPEDA & JONG RESIDENCE 21-23 FRANCESCA AVE. SOMERVILLE, MA 02144

time I favore franciscopore franciscopore fa Eq fraganisms 3 Minter Tiped Sampride Mersens (Int) Miles (72 (Int) Miles (7) Fe/

BACKYARD COTTAGE
EXISTING FRONT (NORTH) ELEVATION

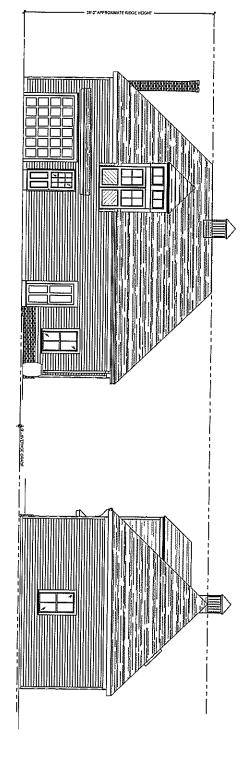

BACKYARD COTTAGE
EXISTING SIDE (WEST) ELEVATION

EX-202



BACKYARD COTTAGE EXISTING REAR (SOUTH) ELEVATION





BACKYARD COTTAGE
EXISTING SIDE (EAST) ELEVATION







ico merdis Ambrila palatical Esperante

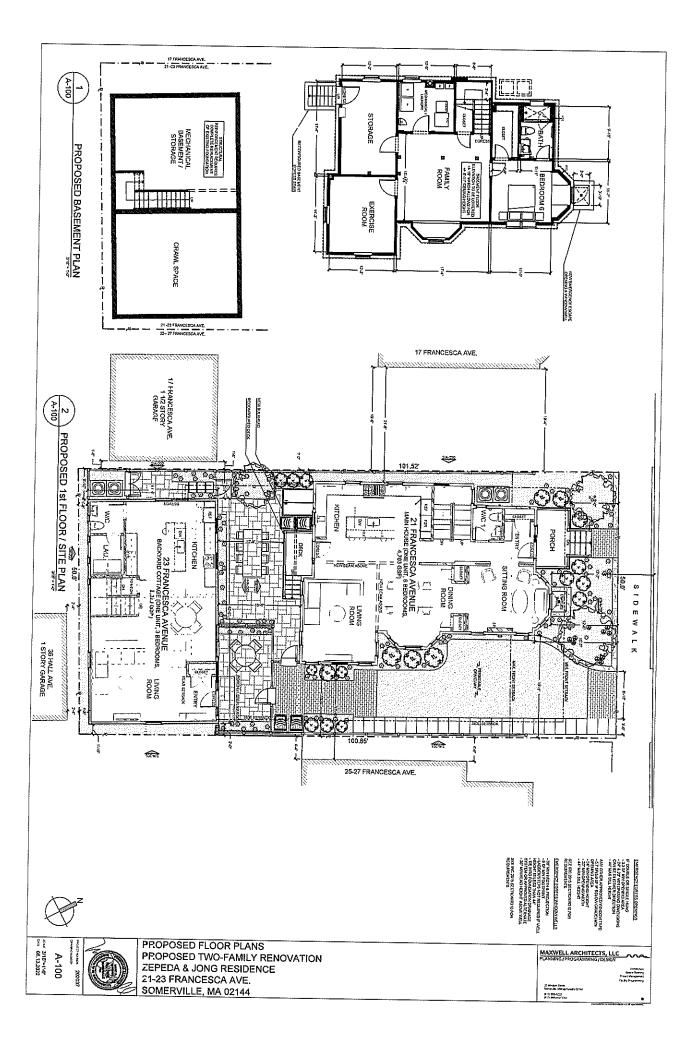

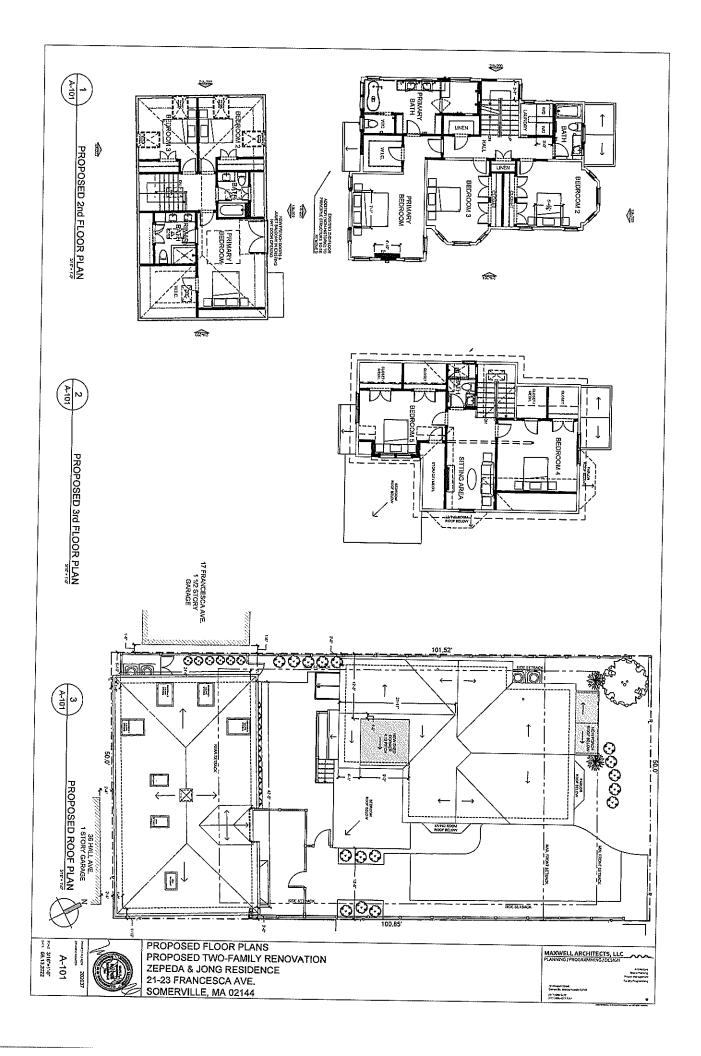


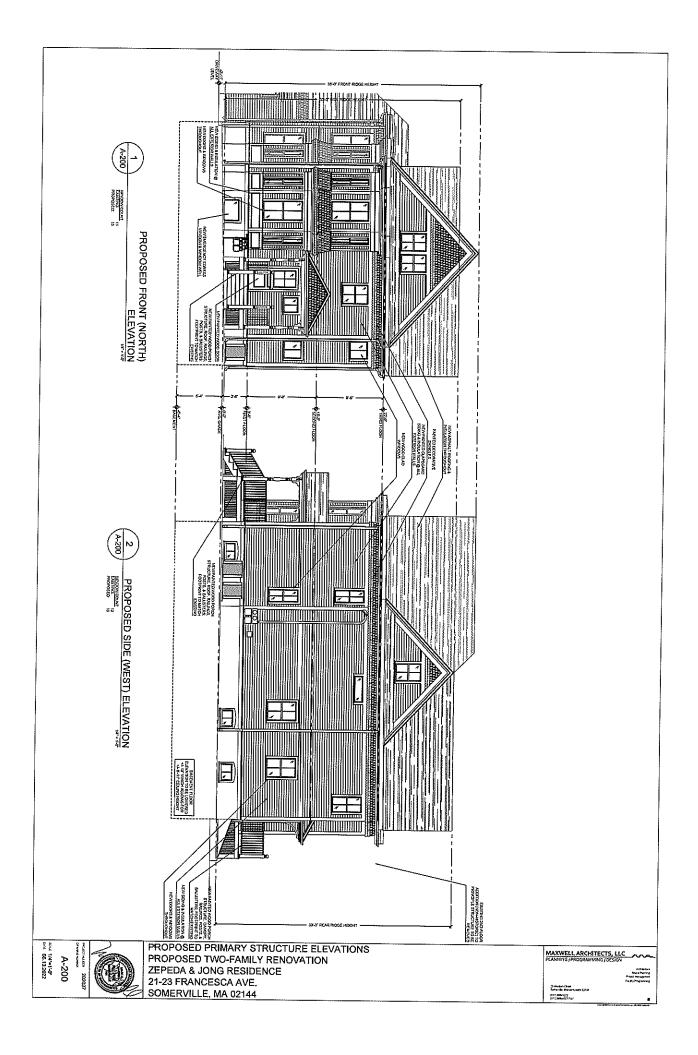



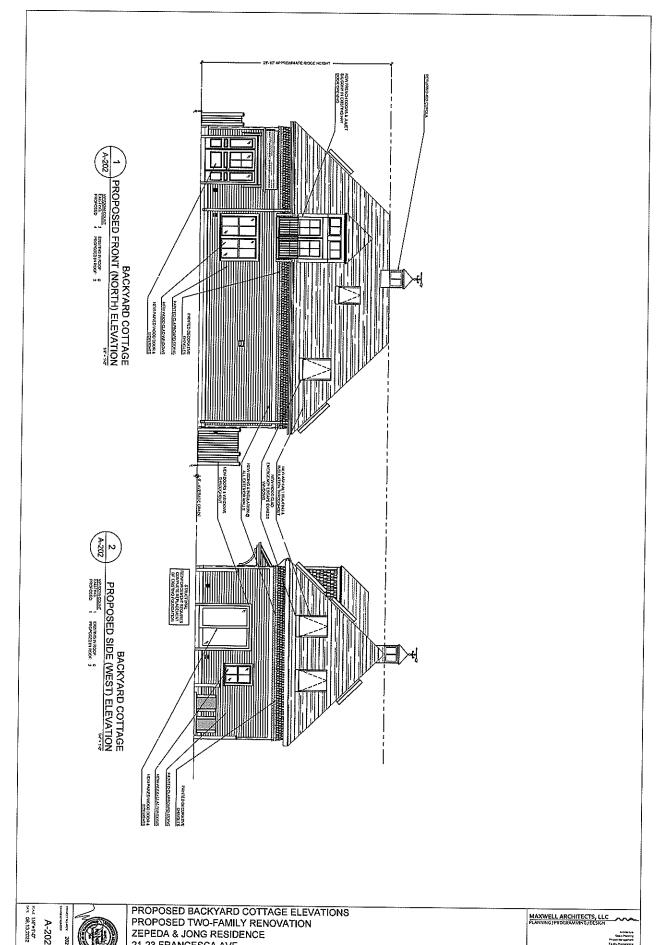

A-202

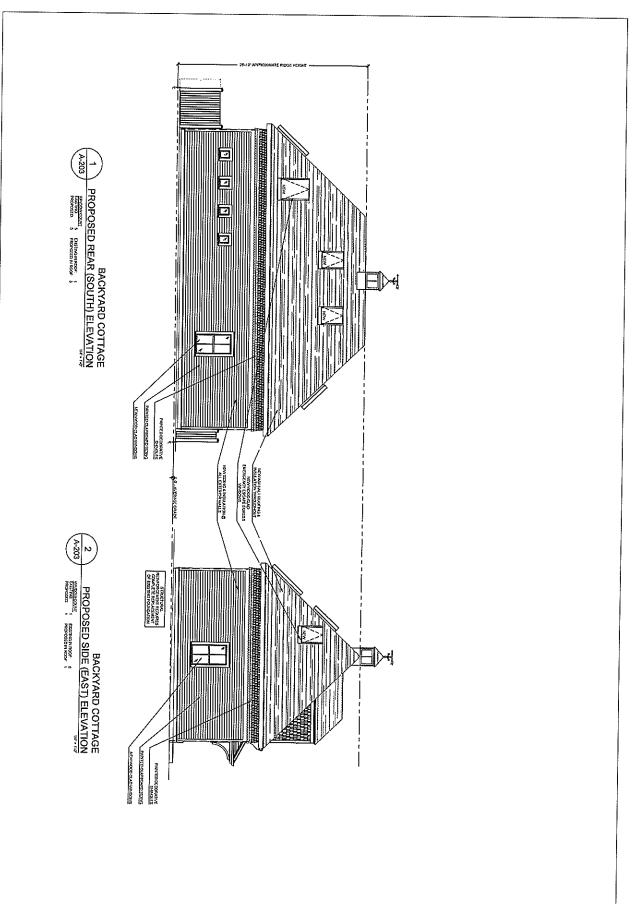

PROPOSED BACKYARD COTTAGE ELEVATIONS PROPOSED TWO-FAMILY RENOVATION ZEPEDA & JONG RESIDENCE 2°-23 FRANCESCA AVE, SOMERVILLE, MA 02144

MAXWELL ARCHITECTS, LLC PLANNING (PROGRAMMING (DESIGN



#### City of Somerville

## **ZONING BOARD OF APPEALS**

City Hall 3<sup>rd</sup> Floor, 93 Highland Avenue, Somerville MA 02143

#### **AGENDA** Wednesday, September 21, 2022 at 6:00 pm

The meeting will be held using GoToWebinar. TO USE A COMPUTER

Link:

https://attendee.gotowebinar.com/register/10369919652208140

Webinar ID:

932-908-051

TO CALL IN

Phone number: 1 (914) 614-3221 Access code: 765-761-656

Pursuant to Chapter 107 of the Acts of 2022, this meeting of the Somerville Zoning Board of Appeals will be conducted via remote participation. A recording of these proceedings can be accessed at any time using the registration link at the top of this agenda.

#### GENERAL BUSINESS

Approval of minutes

None

Rescheduled or withdrawal of advertised public hearings

None

#### **PUBLIC HEARINGS**

10 Oak Street (P&Z 21-132) (continued from September 7, 2022) (will be continued to October 12, 2022) Fidelis Bridge Loan Venture V REO LLC seeks an extension to a previously issued Special Permit (ZBA 2018-10) in the Urban Residential (UR) District.

21 Francesca Avenue (P&Z 21-031) (will be continued to October 12, 2022) Manuel Zepeda and Katherine Jong propose to establish a Backyard Cottage in the Neighborhcod Residence (NR) district which requires Site Plan Approval.

#### OTHER BUSINESS

None

Plans and reports are available to view at the City of Somerville website via the following link: https://www.somervillema.gov/departments/ospcd/planning-and-zoning/reports-and-decisions

Individuals with disabilities who need auxiliary aids and services for effective communication, written materials in alternative formats, or reasonable modifications in policies and procedures, in order to access the programs and activities of the City of Somerville or to attend meetings, should contact Nancy Bacci, at 617-625-6600 x2250 or nbacci@somervillema.gov.

# PROPOSED BACKYARD COTTAGE RENOVATION 21-23 FRANCESCA AVENUE SOMERVILLE, MASSACHUSETTS 02144

OWNER
Manuel Zepeda & Katherine Jong
21 Francesca Avenue
Somerville, MA 02144
617.233.7227

ARCHITECT
Marc A. Maxwell, AIA
Principal Architect

John Williams, AIA Project Architect

Maxwell Architects LLC 20 Windom Street Somerville, MA 02145 617.666.9222

STRUCTURAL ENGINEER
Structures North Consulting Engineers, Inc.

Structures North Consulting Engineers, In 60 Washington Street, Suite 401 Salem, MA 01970 978.745.6817

#### **BUILDING CODE ANALYSIS:**

780 CMR 9th Edition - 2015 ICC with MA amendments

Use Group: R-3 (no change)
Construction Type: V

IEBC

Proposed work is a Level 3 Alteration 801.3 All new construction elements, components, systems, and spaces shall comply with the requirements of the IBC. 908.1 Level 3 alterations to existing buildings or structures are permitted without requiring the entire or structure to comply with the energy requirements of the IECC or IRC. The alterations shall conform to the energy requirements of the IECC or IRC as they relate to new construction only.

IECC:

R501.1.1 Additions, alterations, or repairs to an existing building, building system or portion thereof shall comply with section R502, R503 or R504. Unaltered portions of the existing building or building supply system shall not be required to comply with this code. Insulation and fenestration requirements by component:

-Climate zone 5
-Fenestration U-factor: .30
-Skylight U-factor: .55
-Ceiling R-value: 49 (See R402.2.2 for ceilings without attic

spaces, R-30 min)
-Wood frame wall R-value: 20 or 13+5ci
-Mass wall R-value: 13/17

-Floor R-value: 30 (Or fill framing cavity, R-19 min)
-Basement wall R-value: 15/19
-Slab R-value & depth: 10, 4'

-Slab R-value & depth: 10, 4' -Crawl space wall R-value: 15/19

RC:

R310.1 Basements, habitable attics, and every sleeping room shall have not less than one operable emergency escape and rescue opening.
R311.1 Dwellings shall be provided with a means of egress in

accordance with section R311.
R313.2 Only one- and two-family dwellings having an aggregate area greater than 14,400 SF shall have fire sprinklers installed in

accordance with NFPA 13D R313.2.1 Automatic residential fire sprinkler systems shall be designed and installed in accordance with Section NFPA 13D


## PROJECT NARRATIVE:

This project consists of a full gut renovation of the existing barn structure on the property and convert it to a Backyard Cottage (1 dwelling unit). All existing MEP-FA systems will be replaced with new high efficiency systems to meet current building codes and standards. Insulation and energy conservation components will also be upgraded to meet current building codes and standards. The existing barn requires extensive structural modification and reinforcement to accommodate the conversion and preserve the existing building; including a full foundation replacement. Expansive existing asphalt will be removed and replaced with green score compliant landscaping and permeable surfaces.

#### **ZONING ANALYSIS**

#### Zone: NR

3.1.12 Backyard Cottage			
,	Required	Provided	
Lot Dimensions	'		
Lot Width (front driveway access)	34 ft	50 ft (existing)	conforming
Lot Depth	80 ft	101.52 ft (existing)	conforming
Lot Development			
Lot Coverage (maximum)	60%	49%	conforming
Green Score	0.35 minimum	0.38	conforming
Building Setbacks			
Primary Front Setback (min/max)	60 ft (min)	74'-9" (existing)	conforming
Side Setbacks	3 ft	1'-10" east	existing non-conforming
	3 ft	5'-7" west	conforming
Rear Setback (min) Main House	3 ft	1'-8"	existing non-conforming
Building Separation (min)			
Main house to Carriage House	10 ft	15'-6"	conforming
Carriage House to 17-19 Garage	10 ft	7'-1"	existing non-conforming
Main Massing			
Width (max)	24 ft	42'-5"	existing non-conforming
Depth (max)	32 ft	24'-5"	conforming
Floor Plate (max)	576 sf	975 sf (existing)	existing non-conforming
Story Height (max)	12 ft	10'-9" (existing)	conforming
Number of Stories (max)	1.5	1.5	conforming
Roof Type	Flat, Gable	Gable/Hip with Cupola	conforming
Façade Composition			
Ground Story Fenestration Residential Use (min/max)	15%- 50%	19%	conforming
Ground Story Fenestration Vehicular Parking (min/max)	0%- 50%	0%	conforming
Upper Story Fenestration (min/max)	15%-50%	NA	
Use & Occupancy			
Dwelling Units per Lot (max)	3	2	conforming
Dwelling Units (max)	1	1	conforming

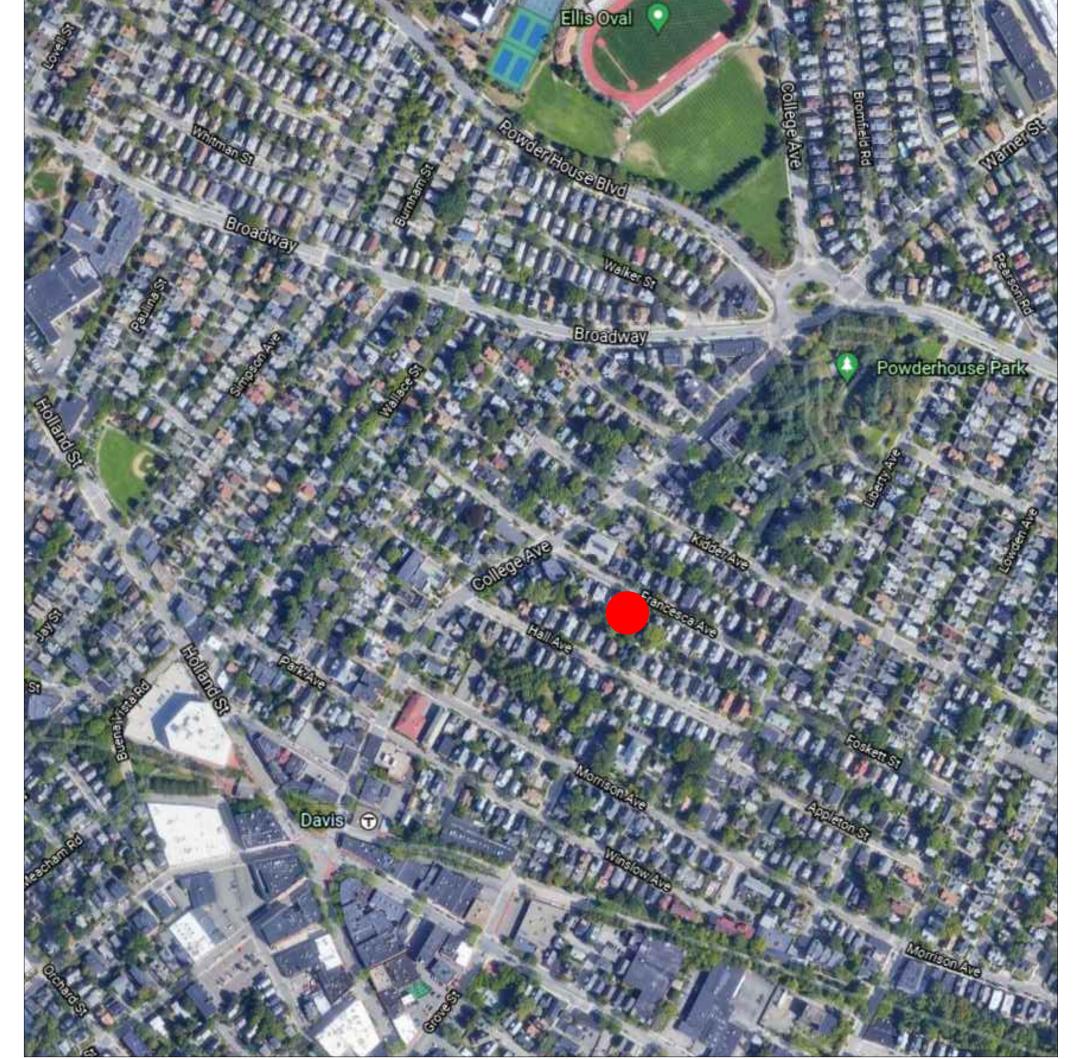






PROPOSED MASSING MODEL

PROPOSED ZONING ANALYSIS, LOCUS, 8
PROPOSED RESIDENTIAL RENOVATION
ZEPEDA & JONG RESIDENCE
21-23 FRANCESCA AVE.
SOMERVILLE, MA 02144

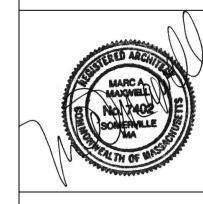

PROJECT NUMBER: 202037
DRAWING NUMBER:

T-100

SCALE: AS NOTED DATE: 09.16.2022

SHEET	TITLE	DATE
	ARCHITECTURAL	T
T-100	PROPOSED ZONING ANALYSIS, ZONING & MASSING	09.16.20
T-101	TITLE SHEET, LEGENDS & GENERAL NOTES	09.16.20
EX-100	EXISTING PLANS	09.16.20
EX-101	EXISTING PLANS	09.16.20
EX-200	EXISTING PRIMARY STRUCTURE ELEVATIONS	09.16.20
EX-201	EXISTING PRIMARY STRUCTURE ELEVATIONS	09.16.20
EX-202	EXISTING BACKYARD COTTAGE ELEVATIONS	09.16.20
EX-203	EXISTING BACKYARD COTTAGE ELEVATIONS	09.16.20
AD-111	BASEMENT & FIRST FLOOR DEMO PLANS	09.16.20
AD-112	SECOND FLOOR DEMO PLANS	09.16.20
A-100	PROPOSED SITE PLAN & ROOF PLAN	09.16.20
A-111	BYC BASEMENT & FIRST FLOOR PLANS	09.16.20
A-112	BYC SECOND FLOOR PLAN	09.16.20
A-113	BYC BASEMENT & FIRST FLOOR RC PLANS	09.16.20
A-114	BYC SECOND FLOOR RC PLAN	09.16.20
A-202	BYC PROPOSED NORTH & WEST ELEVATION	09.16.20
A-203	BYC PROPOSED SOUTH & EAST ELEVATION	09.16.20
A-400	BYC PROPOSED - 208 - PRIM BATH FLOOR PLANS	09.16.20
A-401	BYC PROPOSED - 208 - PRIM BATH FLOOR ELEVATIONS	09.16.20
A-402	BYC PROPOSED - 205 - BATH 1 FLOOR PLANS	09.16.20
A-403	BYC PROPOSED - 205 - BATH 1 ELEVATIONS	09.16.20
A-404	BYC PROPOSED - W/C 1 105 / LAUNDRY 106 F. PLANS	09.16.20
A-405	BYC PROPOSED - W/C 1 105 ELEVATIONS	09.16.20
A-405	BYC PROPOSED - LAUNDRY 106 ELEVATIONS	09.16.20
	STRUCTURAL (BYC)	
S-001	BYC NOTES	09.15.20
S-101	BYC FRAMING PLANS	09.15.20
S-201	BYC DETAILS	09.15.20
S-202	BYC DETAILS	09.15.20

LEGEND	
	NEW GWB PARTITION
	NEW GWB PARTITION W/ 2x6 FRAMING OR AS REQUIRED FOR PLUMBING
	PARTITION/COMPONENT TO BE DEMOLISHED
\$	ELECTRICAL SWITCH
<b>\$</b>	3-WAY ELECTRICAL SWITCH
<b>†</b>	TIMER SWITCH
abla	DATA JACK
Ф	DUPLEX OUTLET
#	QUADPLEX OUTLET
Ш	GFCI OUTLET
0	COAXIAL CABLE JACK
T	THERMOSTAT
The same of the sa	ELECTRICAL CIRCUIT
$\oplus$	RECESSED CEILING LIGHT FIXTURE
•	RECESSED CEILING WET LOCATION LIGHT FIXTURE
	CEILING MOUNTED PENDANT LIGHT FIXTURE
	SURFACE MOUNTED WALL SCONCE
$\oplus$	SURFACE MOUNTED CEILING LIGHT FIXTURE
<u> </u>	SIDE MOUNTED LINEAR LIGHT FIXTURE
	SURFACE MOUNTED CLOSET LIGHT FIXTURE
a	UNDER CABINET/SHELF LINEAR LIGHT FIXTURE
	CEILING MOUNTED EXHAUST FAN
→ SD	SMOKE DETECTOR
⊕co	CO DETECTOR

# REFLECTED CEILING PLAN NOTES

- NEW MEP-FA SYSTEMS; SEE MEP-FA DRAWINGS. SUBMIT COORDINATED SHOP DRAWINGS FOR APPROVAL.
- DIMENSIONS & WORK NOTED ON THESE DRAWINGS ARE NOTED FOR DESIGN INTENT. NOTIFY ARCHITECT PRIOR TO INSTALLATION IF THE INSTALLATION OF ELECTRICAL, MECHANICAL, PLUMBING, OR FIRE PROTECTION WORK INTERFERES WITH THIS INTENT.
- REFER TO ELECTRICAL DRAWINGS FOR ALL CIRCUITING & SWITCHING INFORMATION. NOTIFY ARCHITECT OF DISCREPANCIES PRIOR TO INSTALLATION.
- GROUPINGS OF SPRINKLER HEADS, LIGHT FIXTURES, DIFFUSERS, ETC. TO BE CENTERED WITHIN ROOMS, UNO.
- COORDINATE LINEAR RUNS OF SPRINKLER HEADS, LIGHT FIXTURES, DIFFUSERS, ETC, TO BE ALIGNED ON CENTER, UNO.
- DIMENSIONS ARE TO CENTER OF FIXTURE, UNO.
- HVAC DIFFUSERS, EQUIPMENT ACCESS PANELS, SPRINKLER HEAD ESCUTCHEON PLATES, SMOKE DETECTORS, SECURITY FEATURES, AUDIO DEVICES, ETC. TO MATCH ADJACENT CEILING FINISH, UNO.
- DEMO OBSOLETE EQUIPMENT. CABLING. WIRING. & DEVICES.
- PROVIDE 7'-6" MIN. CEILING HEIGHT. RELOCATE EXISTING OBSTRUCTIONS AS REQUIRED.
- CEILING HEIGHTS NOTED ARE FROM TOP OF FINISHED FLOOR TO UNDERSIDE OF FINISHED CEILING, UNO.
- ALL ELECTRICAL CONDUIT, WIRING, PLUMBING LINES, & OTHER SERVICES TO BE ROUTED THROUGH CLOSED CEILINGS, FRAMED WALLS, ETC. AS NECESSARY TO CONCEAL FROM VIEW, UNO.
- CONFIRM CEILING HEIGHTS NOTED PROVIDE ADEQUATE CLEARANCE FOR ALL EXISTING & NEW MEP-FA EQUIPMENT & COMPONENTS.
- PROVIDE ACCESS PANELS TO ALL ABOVE CEILING & IN WALL CONTROLS, TRANSFORMERS, SHUT OFFS, ETC.. COORDINATE EXACT LOCATIONS, SIZES, & QUANTITIES W/ ARCHITECT/OWNER.

#### **GENERAL NOTES**

- COMPLY WITH APPLICABLE CODES, REGULATIONS, ORDINANCES AND REQUIREMENTS OF AUTHORITIES HAVING JURISDICTION, INCLUDING ACCESSIBILITY GUIDELINES WHERE APPLICABLE. SUBMIT COPIES OF INSPECTION REPORTS, NOTICES AND SIMILAR DOCUMENTS TO ARCHITECT. PLANS ARE BASED ON MASSACHUSETTS BUILDING CODE 9TH EDITION.
- THE CONTRACTOR, SUBCONTRACTORS, AND MATERIAL SUPPLIERS SHALL REFER TO THE DRAWINGS, SCHEDULES AND SPECIFICATIONS AS A WHOLE WHEN DETERMINING THE CONSTRUCTION REQUIREMENTS FOR THE PROJECT.
- THE CONTRACTOR IS RESPONSIBLE FOR IDENTIFYING ALL AREAS ON THE PROJECT WHICH REQUIRE TOLERANCES BETWEEN ROUGH OPENINGS AND/OR FINISH MATERIALS AND PROVIDE FOR THE PROPER TOLERANCES TO COMPLETE THE CONSTRUCTION IN ACCORDANCE WITH THE REQUIREMENTS OF THE CONTRACT DOCUMENTS.
- ALL DRAWINGS, SCHEDULES AND SPECIFICATIONS IN THE BID PACKAGE ARE TO BE CONSIDERED EQUAL PARTS OF THIS CONTRACT PACKAGE. THE CONTRACTOR AND SUBCONTRACTORS SHALL BE RESPONSIBLE FOR THE REVIEW AND COORDINATION OF ALL DRAWINGS, SCHEDULES AND SPECIFICATIONS. ALL DISCREPANCIES OMISSIONS OR ERRORS THAT OCCUR SHALL BE BROUGHT TO THE ATTENTION OF THE ARCHITECT IN WRITING PRIOR TO THE SUBMISSION OF BIDS SO THAT CLARIFICATION MAY BE ISSUED.
- DRAWINGS AND SPECIFICATIONS ARE INTENDED TO PROVIDE THE BASIS FOR THE PROPER COMPLETION OF THE PROJECT SUITABLE FOR THE INTENDED USE OF THE OWNER. ITEMS NOT EXPRESSLY SET FORTH BUT WHICH ARE REASONABLY IMPLIED OR NECESSARY FOR THE PROPER PERFORMANCE OF THIS WORK SHALL BE INCLUDED.
- ANY WORK PERFORMED IN CONFLICT WITH ANY PART OF THE CONTRACT DOCUMENTS OR ANY CODE REQUIREMENT SHALL BE
- CORRECTED BY THE CONTRACTOR AT THEIR OWN EXPENSE AND AT NO EXPENSE TO THE OWNER OR ARCHITECT • THE CONTRACTOR SHALL NOTIFY THE ARCHITECT WHEN, IN THE COURSE OF CONSTRUCTION OR DEMOLITION, CONDITIONS ARE UNCOVERED WHICH ARE UNANTICIPATED OR OTHERWISE APPEAR TO PRESENT A DANGEROUS CONDITION.
- THE CONTRACTOR AND SUBCONTRACTORS SHALL BE RESPONSIBLE FOR COORDINATION OF THEIR WORK WITH THE WORK OF OTHER TRADES. SUBCONTRACTORS SHALL VERIFY THAT ANY WORK RELATED TO THEM, WHICH MUST BE PROVIDED BY OTHERS HAS BEEN COMPLETED AND IS ADEQUATE PRIOR TO COMMENCING THEIR WORK.
- ALL DIMENSIONS SHALL TAKE PRECEDENCE OVER SCALE SHOWN ON PLANS, SECTIONS AND DETAILS. DIMENSIONS ARE TO FACE OF FINISH UNLESS OTHERWISE NOTED ON DRAWINGS. DO NOT SCALE DRAWINGS. NOTIFY THE ARCHITECT/ENGINEER OF ANY DISCREPANCIES AND DO NOT PROCEED WITHOUT INSTRUCTIONS/CLARIFICATION.
- THE CONTRACTOR SHALL VERIFY ALL CONDITIONS AND DIMENSIONS AND REPORT ANY DISCREPANCIES TO THE ARCHITECT/ENGINEER.
- VERIFY ALL SITE CONDITIONS PRIOR TO COMMENCING CONSTRUCTION.
- THE CONTRACTOR SHALL BE SOLELY RESPONSIBLE FOR JOB SITE SAFETY OF ITS EMPLOYEES AND OTHER PERSONS IN THE CONSTRUCTION AREA, AS WELL AS FOR THE PROTECTION OF THE SAFETY OF THE IMPROVEMENTS BEING ERECTED AND THE PROPERTY OF THE CONTRACTOR AND/OR OTHER PERSONS, AS A RESULT OF OPERATIONS HEREUNDER.
- CONTRACTOR IS RESPONSIBLE FOR ALL SHORING & SHORING ENGINEERING AS REQUIRED BY THE PROJECT.
- THE CONTRACTOR SHALL BE FULLY AND COMPLETELY LIABLE AT HIS OWN EXPENSE FOR DESIGN, CONSTRUCTION, INSTALLATION AND USE OR NON-USE OF ALL ITEMS AND METHODS INCIDENT TO PERFORMANCE OF EITHER PERSON OR PROPERTY, INCLUDING WITHOUT LIMITATION THE ADEQUACY OF ALL TEMPORARY SUPPORTS, SHORING, BRACING, SCAFFOLDING, MACHINERY OR EQUIPMENT, SAFETY PRECAUTIONS OR DEVICES, AND SIMILAR ITEMS OR DEVICES USED DURING CONSTRUCTION.
- THE CONTRACTOR SHALL FURNISH ALL MATERIALS, LABOR, AND EQUIPMENT NECESSARY TO PROPERLY COMPLETE THE WORK, INCLUDING ITEMS NOT SPECIFICALLY SET FORTH IN THE CONSTRUCTION DOCUMENTS.
- THE CONTRACTOR SHALL COORDINATE ALL WORK WITH THE OWNER OR WITH THE OWNER'S REPRESENTATIVE.
- THE CONTRACTOR SHALL OBTAIN AND BE RESPONSIBLE FOR ALL FEES. PERMITS. AND INSPECTIONS REQUIRED AND ASSOCIATED WITH ALL PHASES OF THE WORK.
- ALL ITEMS TO BE REMOVED SHALL BECOME PROPERTY OF THE CONTRACTOR AND SHALL BE REMOVED ENTIRELY FROM THE PROJECT SITE, UNLESS NOTED OTHERWISE. RETURN ITEMS IDENTIFIED FOR SALVAGE OR REUSE TO THE OWNER/PROPERTY
- THE DRAWINGS ARE NOT INTENDED FOR USE AS SHOP OR ERECTION DRAWINGS. PROVIDE SHOP DRAWINGS WHEN
- CONTRACTOR TO PHASE ALL WORK SUCH THAT THE OCCUPIED PORTIONS OF THE BUILDING ARE SAFE & AVAILABLE THROUGHOUT CONSTRUCTION.
- CONTRACTOR TO PROVIDE TEMPORARY BARRIERS AT ALL FLOOR PENETRATIONS TO PREVENT PHYSICAL BODILY DAMAGE.
- CONTRACTOR TO PROVIDE A CLEAN JOB SITE FREE FROM DEBRIS THROUGHOUT CONSTRUCTION AT ALL FLOORS.
- VERIFY STAGING AREA, PARKING AVAILABILITY, AND RULES FOR USE WITH PROPERTY OWNER.
- MAINTAIN PROPER EMERGENCY EGRESS AND SYSTEMS THROUGHOUT DEMOLITION AND RENOVATION.
- PATCH ALL FINISHES TO MATCH EXISTING ADJACENT AT ALL DEMOLISHED OR ALTERED BUILDING COMPONENTS UNLESS OTHERWISE NOTED
- PLUMBING, ELECTRICAL, MECHANICAL, AUDIO/VISUAL, & FIRE ALARM SYSTEMS TO BE DESIGN/BUILD BY CONTRACTOR. IF SHOWN, COMPONENTS OF THESE SYSTEMS ARE DIAGRAMMATIC & PROVIDED FOR PLANNING PURPOSES ONLY. SEE DRAWINGS PROVIDED BY APPROPRIATE SUBCONTRACTOR &/OR LICENSED ENGINEER.
- SEE STRUCTURAL DRAWINGS FOR ALL STRUCTURAL DETAILS & SPECIFICATIONS.
- INSTALL ALL PRODUCTS, COMPONENTS, & SYSTEMS TO MANUFACTURERS RECOMMENDATIONS & PROVIDE ALL ASSEMBLY & INSTALLATION DETAILS IN ORDER TO COMPLY MANUFACTURER WARRANTY REQUIREMENTS.

# **DEMOLITION NOTES**

- PLAN IS A REPRESENTATION OF ESTIMATED WORK TO BE PERFORMED. ADDITIONAL DEMOLITION WORK MAY BE REQUIRED IN ORDER TO CARRY OUT THE WORK DESCRIBED IN THE CONTRACT DOCUMENTS. REVIEW THE CONTRACT DOCUMENTS IN THEIR ENTIRETY AND VISIT THE SITE TO DEVELOP A FULL UNDERSTANDING OF THE WORK TO BE DONE PRIOR TO ISSUANCE OF BID.
- REMOVE DEBRIS FROM SITE IN AN APPROVED MANNER AND AS DIRECTED BY OWNER. VERIFY ALL LOAD BEARING PARTITIONS & STRUCTURAL COMPONENTS PRIOR TO DEMO; NOTIFY ARCHITECT / ENGINEER IF NOT CALLED OUT IN STRUCTURAL DRAWINGS
- VERIFY ALL ALTERATIONS TO EXISTING STRUCTURE W/ STRUCTURAL DRAWINGS
- PROVIDE SHORING AS REQUIRED FOR DEMOLITION OF EXISTING PARTITIONS &/OR STRUCTURAL ELEMENTS AS SHOWN.
- ALERT OWNER IMMEDIATELY UPON FINDING ANY EXISTING CONDITIONS DURING DEMO THAT ARE NOT NOTED ON THE DRAWINGS THAT MAY AFFECT CONSTRUCTION AND/OR DESIGN.
- REMOVE ALL ABANDONED AND/OR OBSOLETE MISCELLANEOUS ITEMS, CABLING, WIRING, PLUMBING & OTHER UTILITY COMPONENTS THROUGHOUT THE WORK AREA. INCLUDING ABOVE THE CEILING. ONCE VERIFIED AS DISCONNECTED & OBSOLETE.
- REMOVE ALL MECHANICAL, ELECTRICAL, PLUMBING, COMMUNICATION SYSTEMS, & COMPONENTS THAT ARE OBSOLETE. ABANDONED, OR TO BE REPLACED WITH NEW COMPONENTS BACK TO SOURCE. REFER TO MEP-FA DRAWINGS.
- REMOVE SWITCHES, CONTROLS, ETC, THAT ARE TO BE DISCONNECTED. WHERE RECEPTACLES OR SWITCHES ARE TO BE REMOVED OR RELOCATED, ABANDONMENT AND CAP PLATES ARE NOT ACCEPTABLE. REMOVE ALL INFRASTRUCTURE BACK TO SOURCE & PATCH WALL TO MATCH EXISTING WALL CONDITION.
- ALL EXISTING EQUIPMENT THAT REMAINS IN PLACE AND/OR OPERATIONAL DURING THE PROJECT SHALL BE PROTECTED. • ALL EXISTING CONDITIONS TO REMAIN SHALL BE PROTECTED. WHERE DEMOLITION ABUTS EXISTING MATERIAL TO REMAIN,
- PATCH ANY DAMAGES TO MATCH EXISTING ADJACENT SURFACES.
- COORDINATE REMOVAL OF SALVAGED ITEMS WITH OWNER.
- REMOVE ASSOCIATED DOORS, WINDOWS, & ELECTRICAL TEL-DATA WHEN REMOVING INTERIOR PARTITIONS.
- COORDINATE DEMO OF WALLS WITH EXISTING EQUIPMENT TO REMAIN. REFER TO MEP-FA DRAWINGS.
- STRIP EXISTING WALL COVERINGS AT ALL LOCATIONS SCHEDULED TO RECEIVE NEW FINISH.

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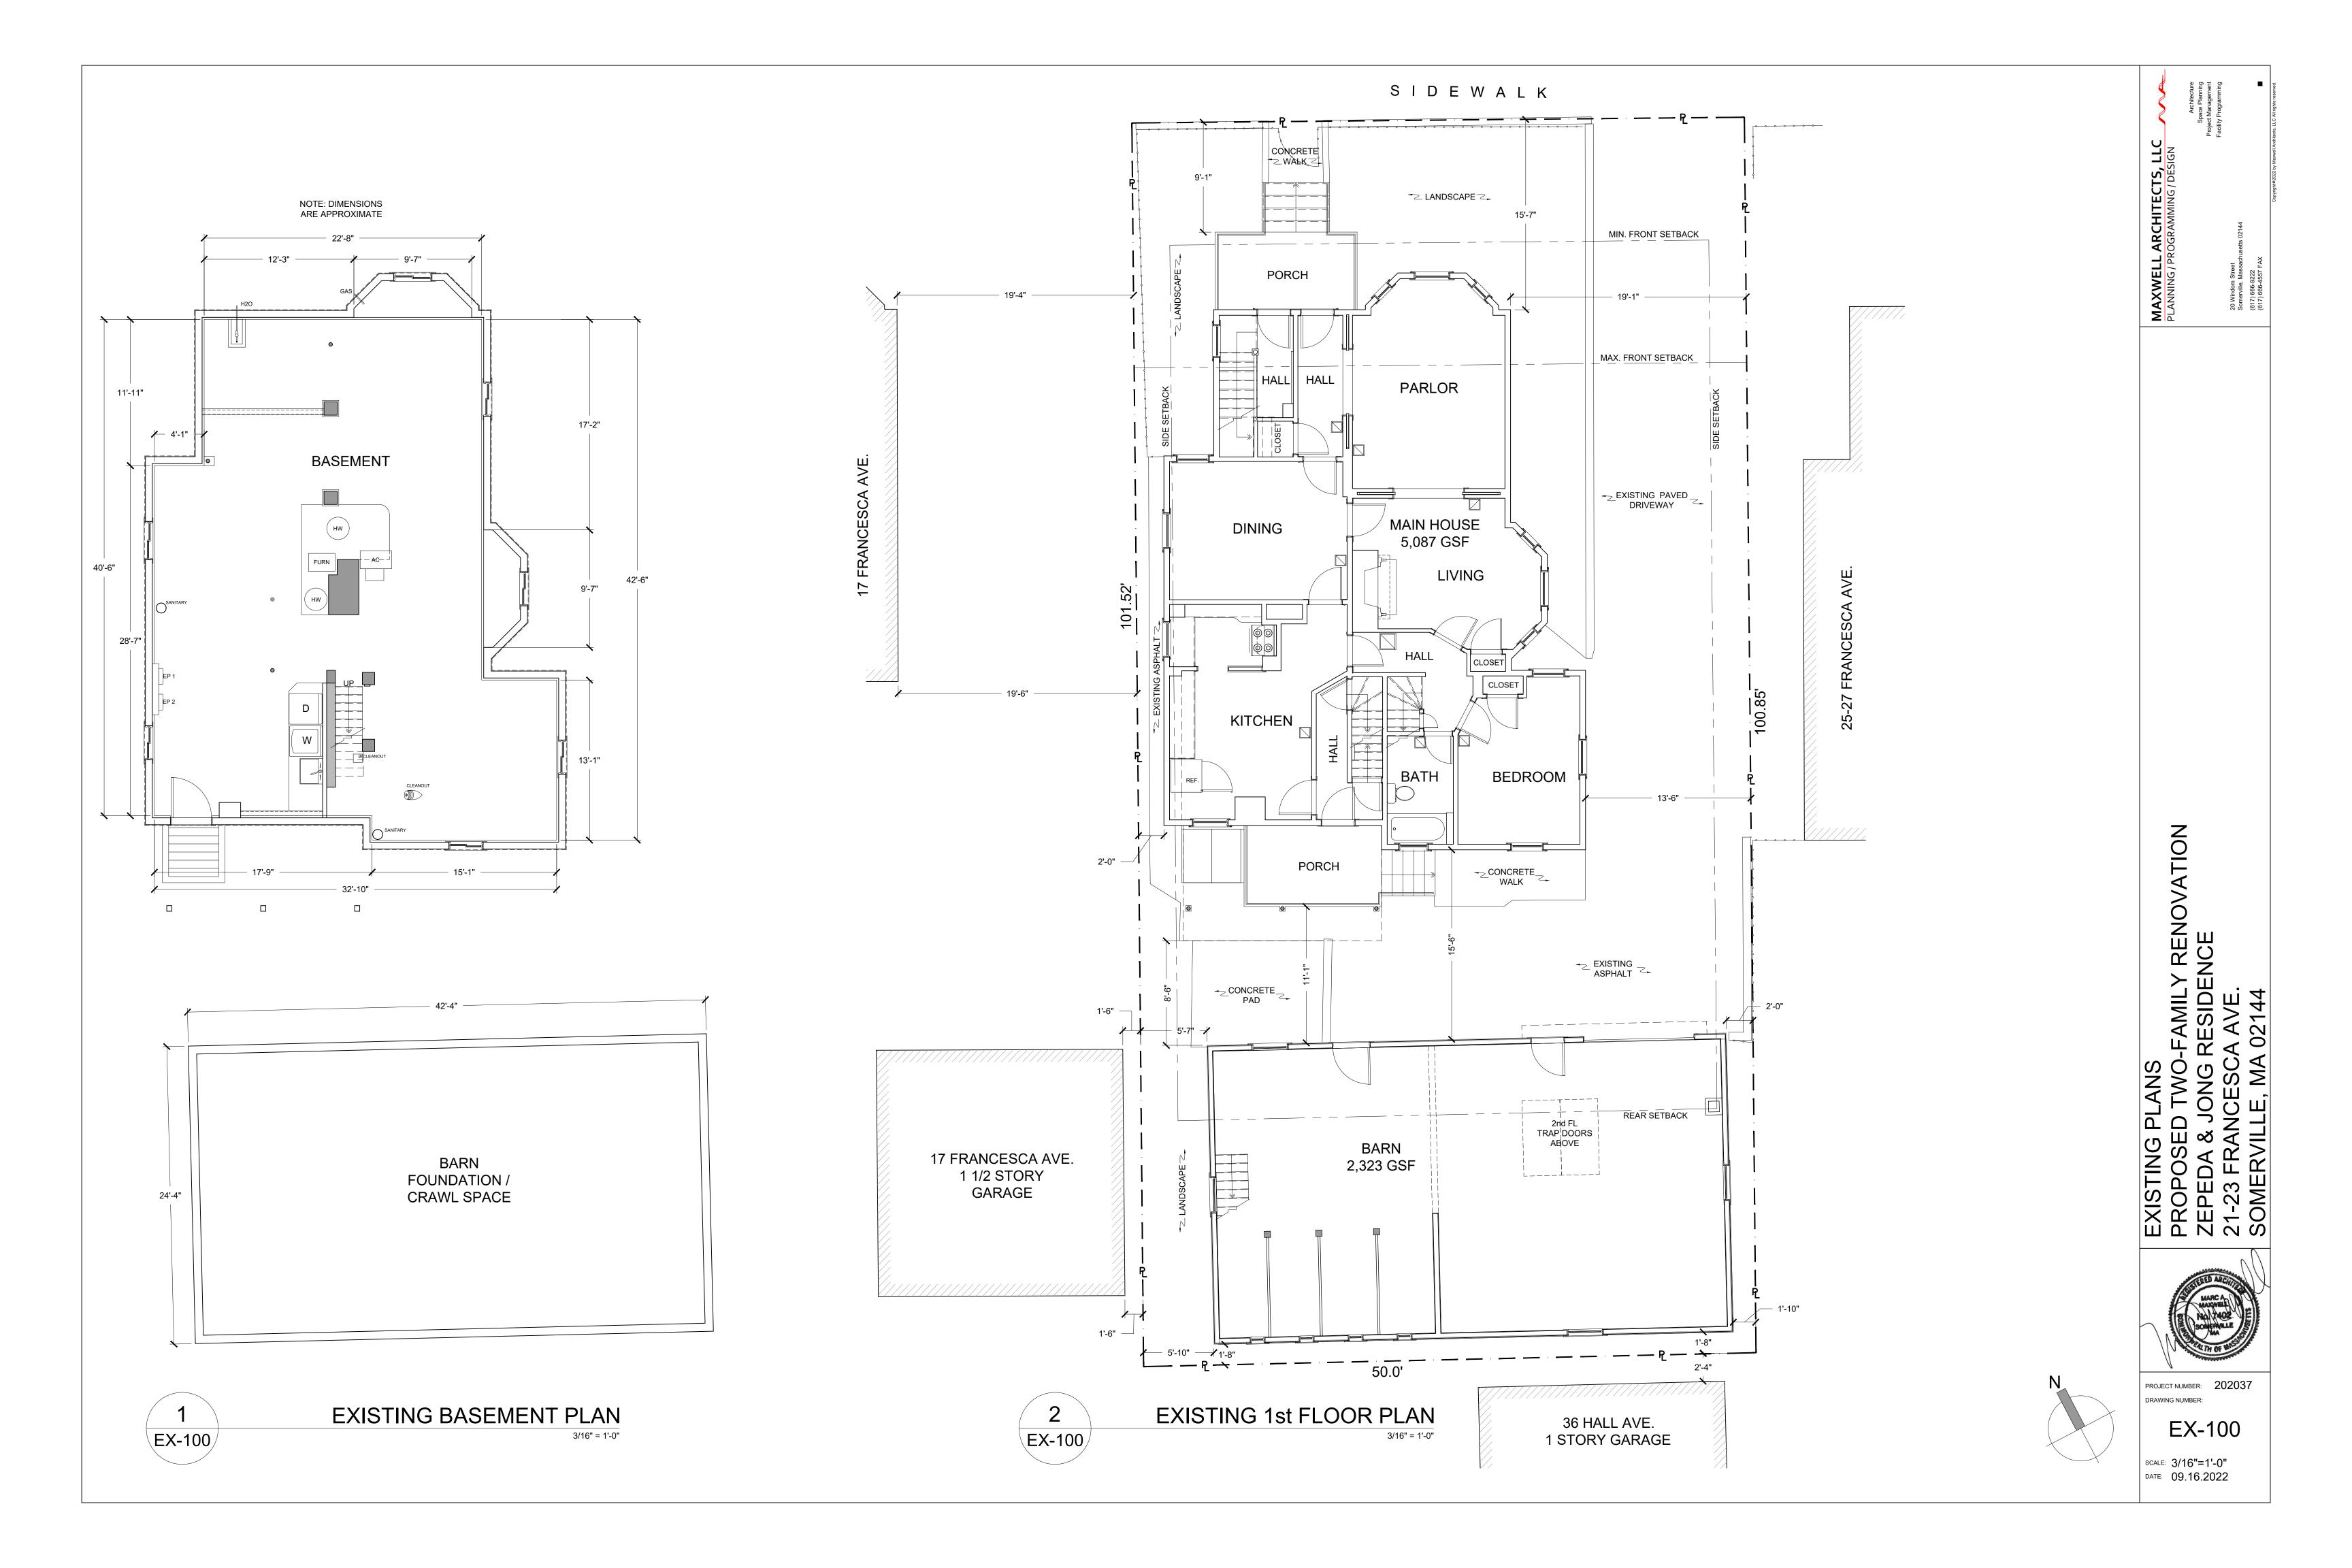
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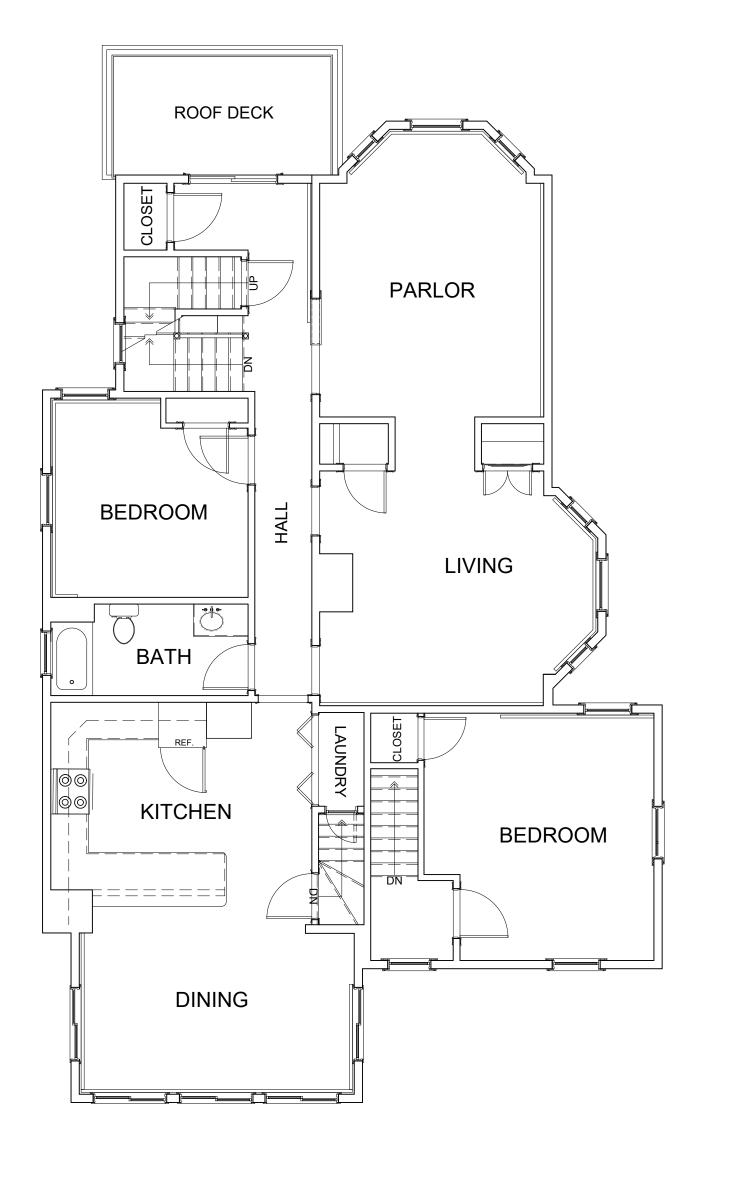



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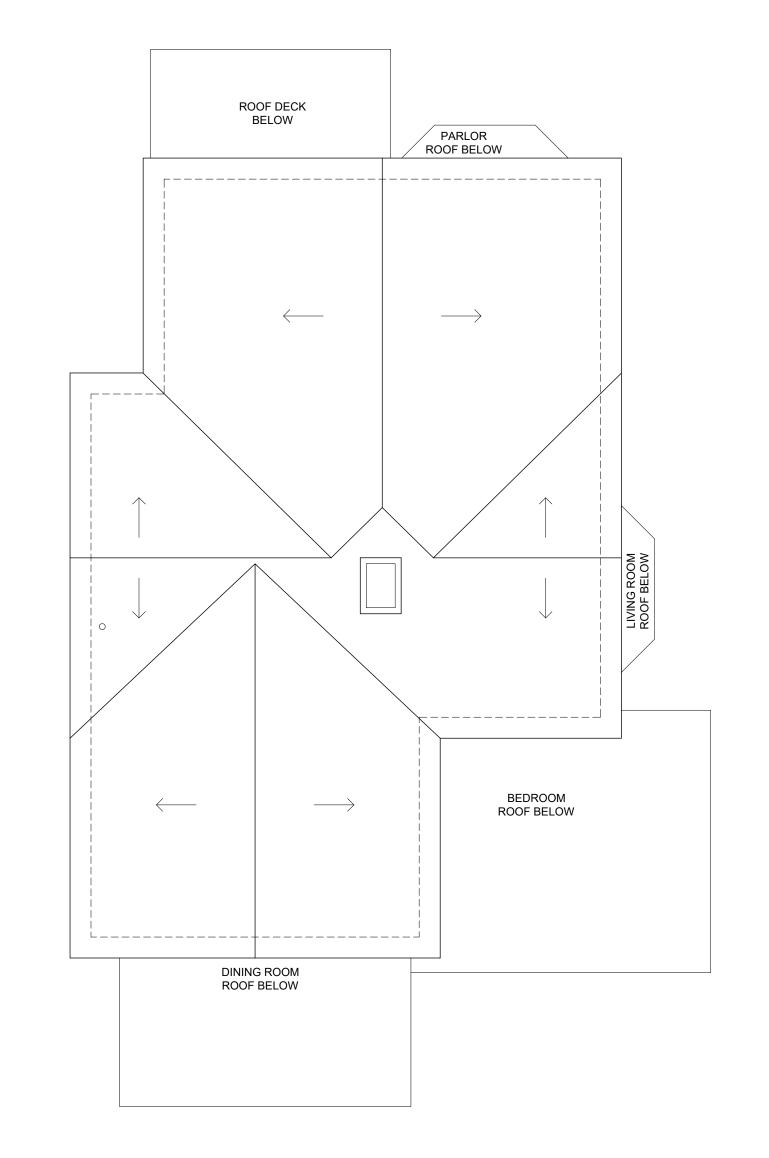
T-101


SCALE: AS NOTED DATE: 09.16.2022








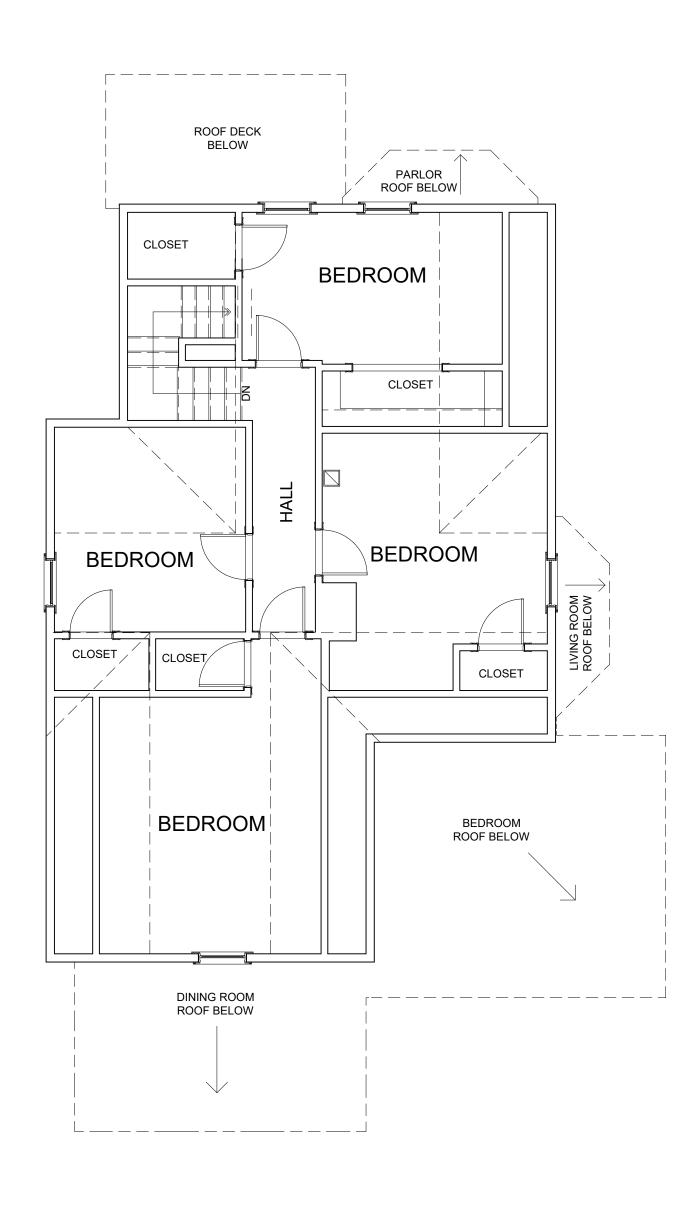


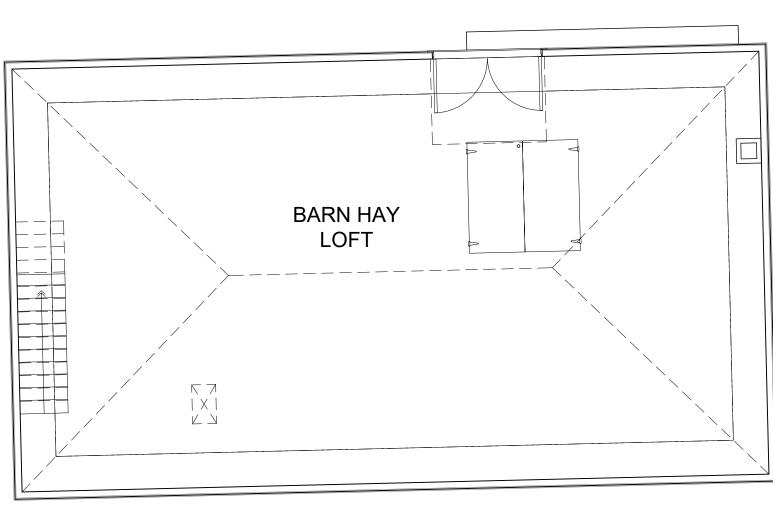


EX-101

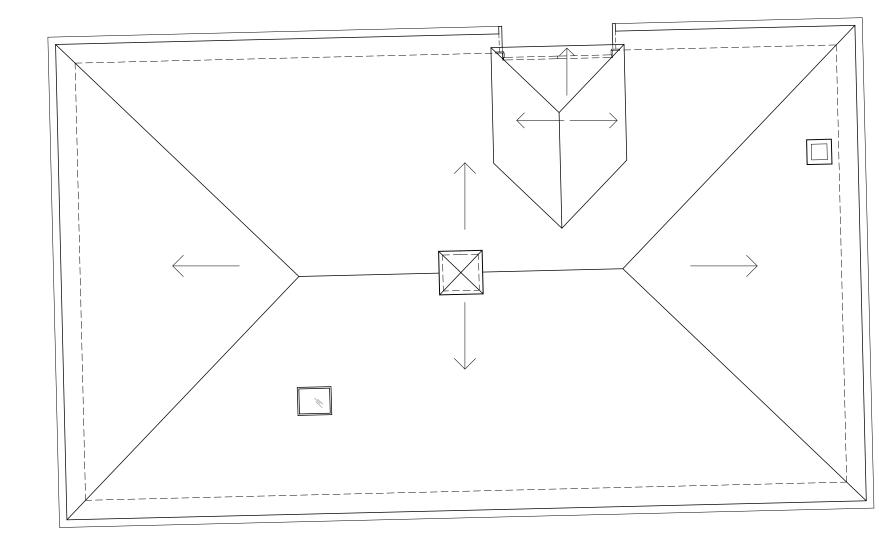

EXISTING ROOF PLAN EX-101/

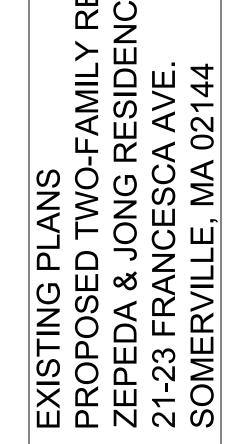

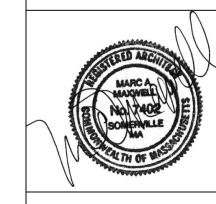

PROJECT NUMBER: 202037

EX-101

SCALE: 3/16"=1'-0"
DATE: 09.16.2022

EXISTING 2nd FLOOR PLAN
3/16" = 1'-0"

EXISTING 3rd FLOOR PLAN





EXISTING PRIMARY STRUCTURE ELEVATION
PROPOSED TWO-FAMILY RENOVATION
ZEPEDA & JONG RESIDENCE
21-23 FRANCESCA AVE.
SOMERVILLE, MA 02144

SCALE: 1/4"=1'-0"
DATE: 09.16.2022



EXISTING BACKYARD COTTAGE ELEVATIONS
PROPOSED TWO-FAMILY RENOVATION
ZEPEDA & JONG RESIDENCE

MARC A MANAGER SOMETHING THE S

PROJECT NUMBER: 20203

EX-202





EXISTING BACKYARD COTTAGE ELEVATIONS
PROPOSED TWO-FAMILY RENOVATION
ZEPEDA & JONG RESIDENCE
21-23 FRANCESCA AVE.
SOMERVILLE, MA 02144

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PROJECT NUMBER: 20203
DRAWING NUMBER:

EX-203



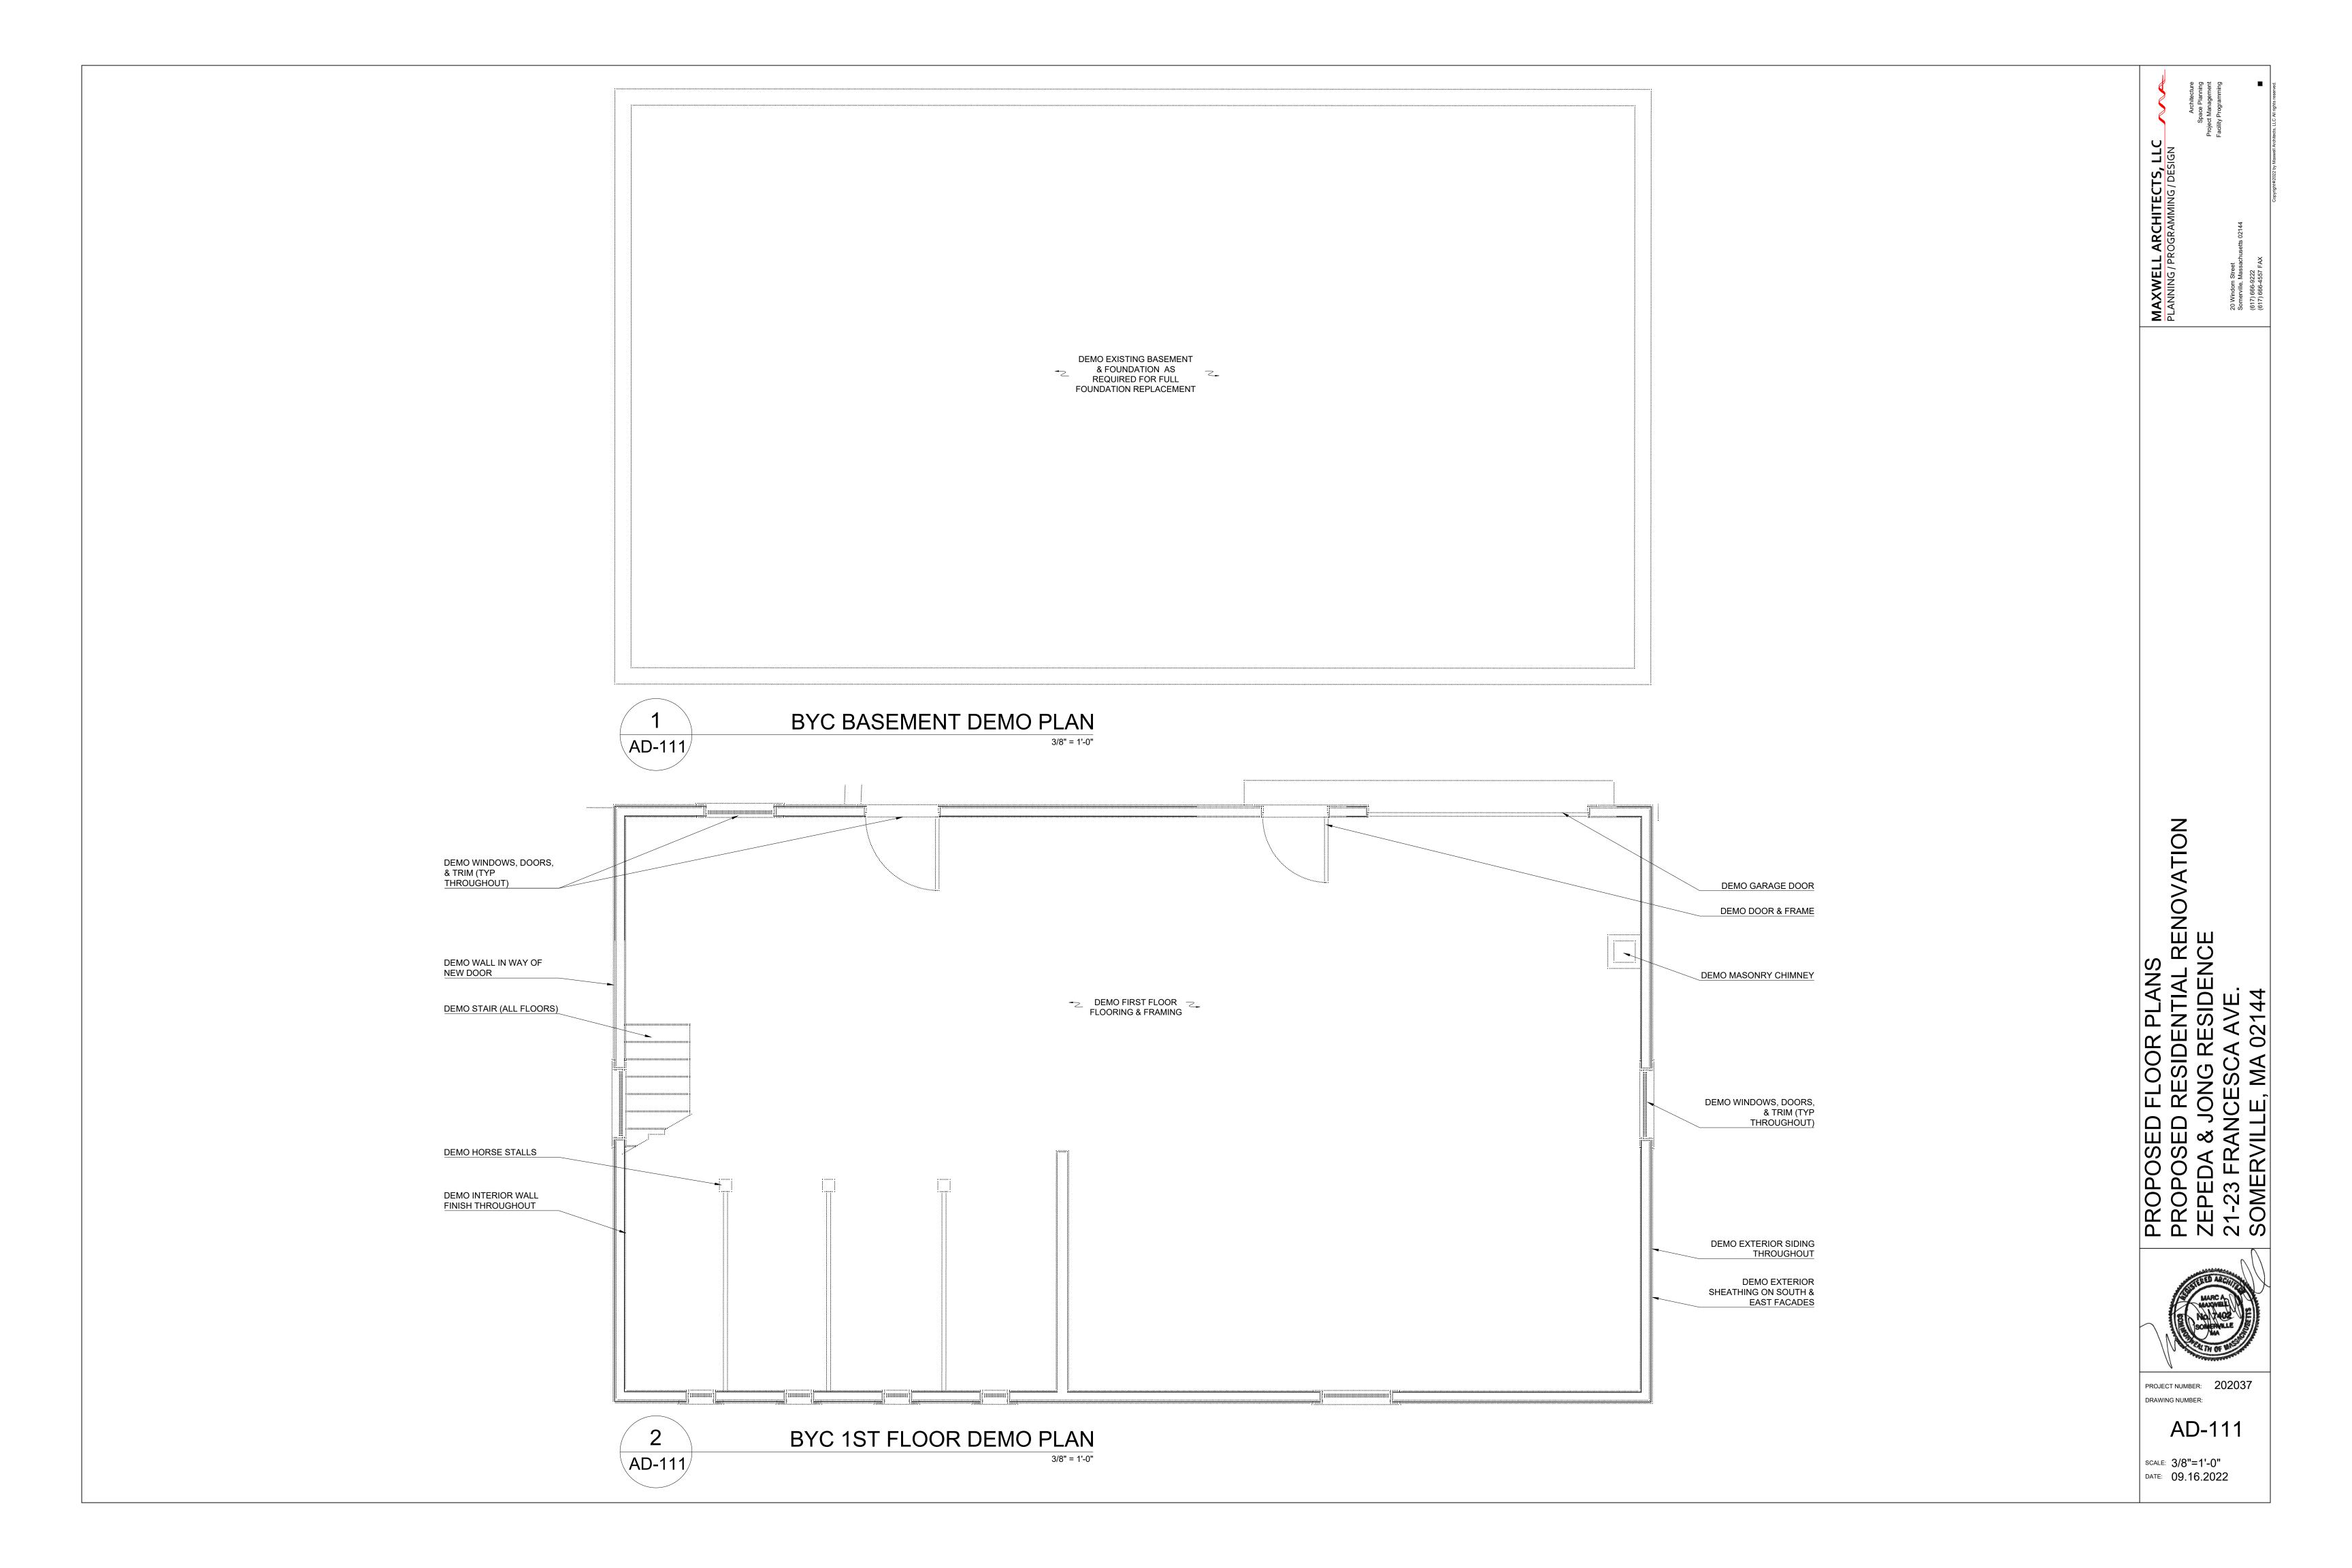

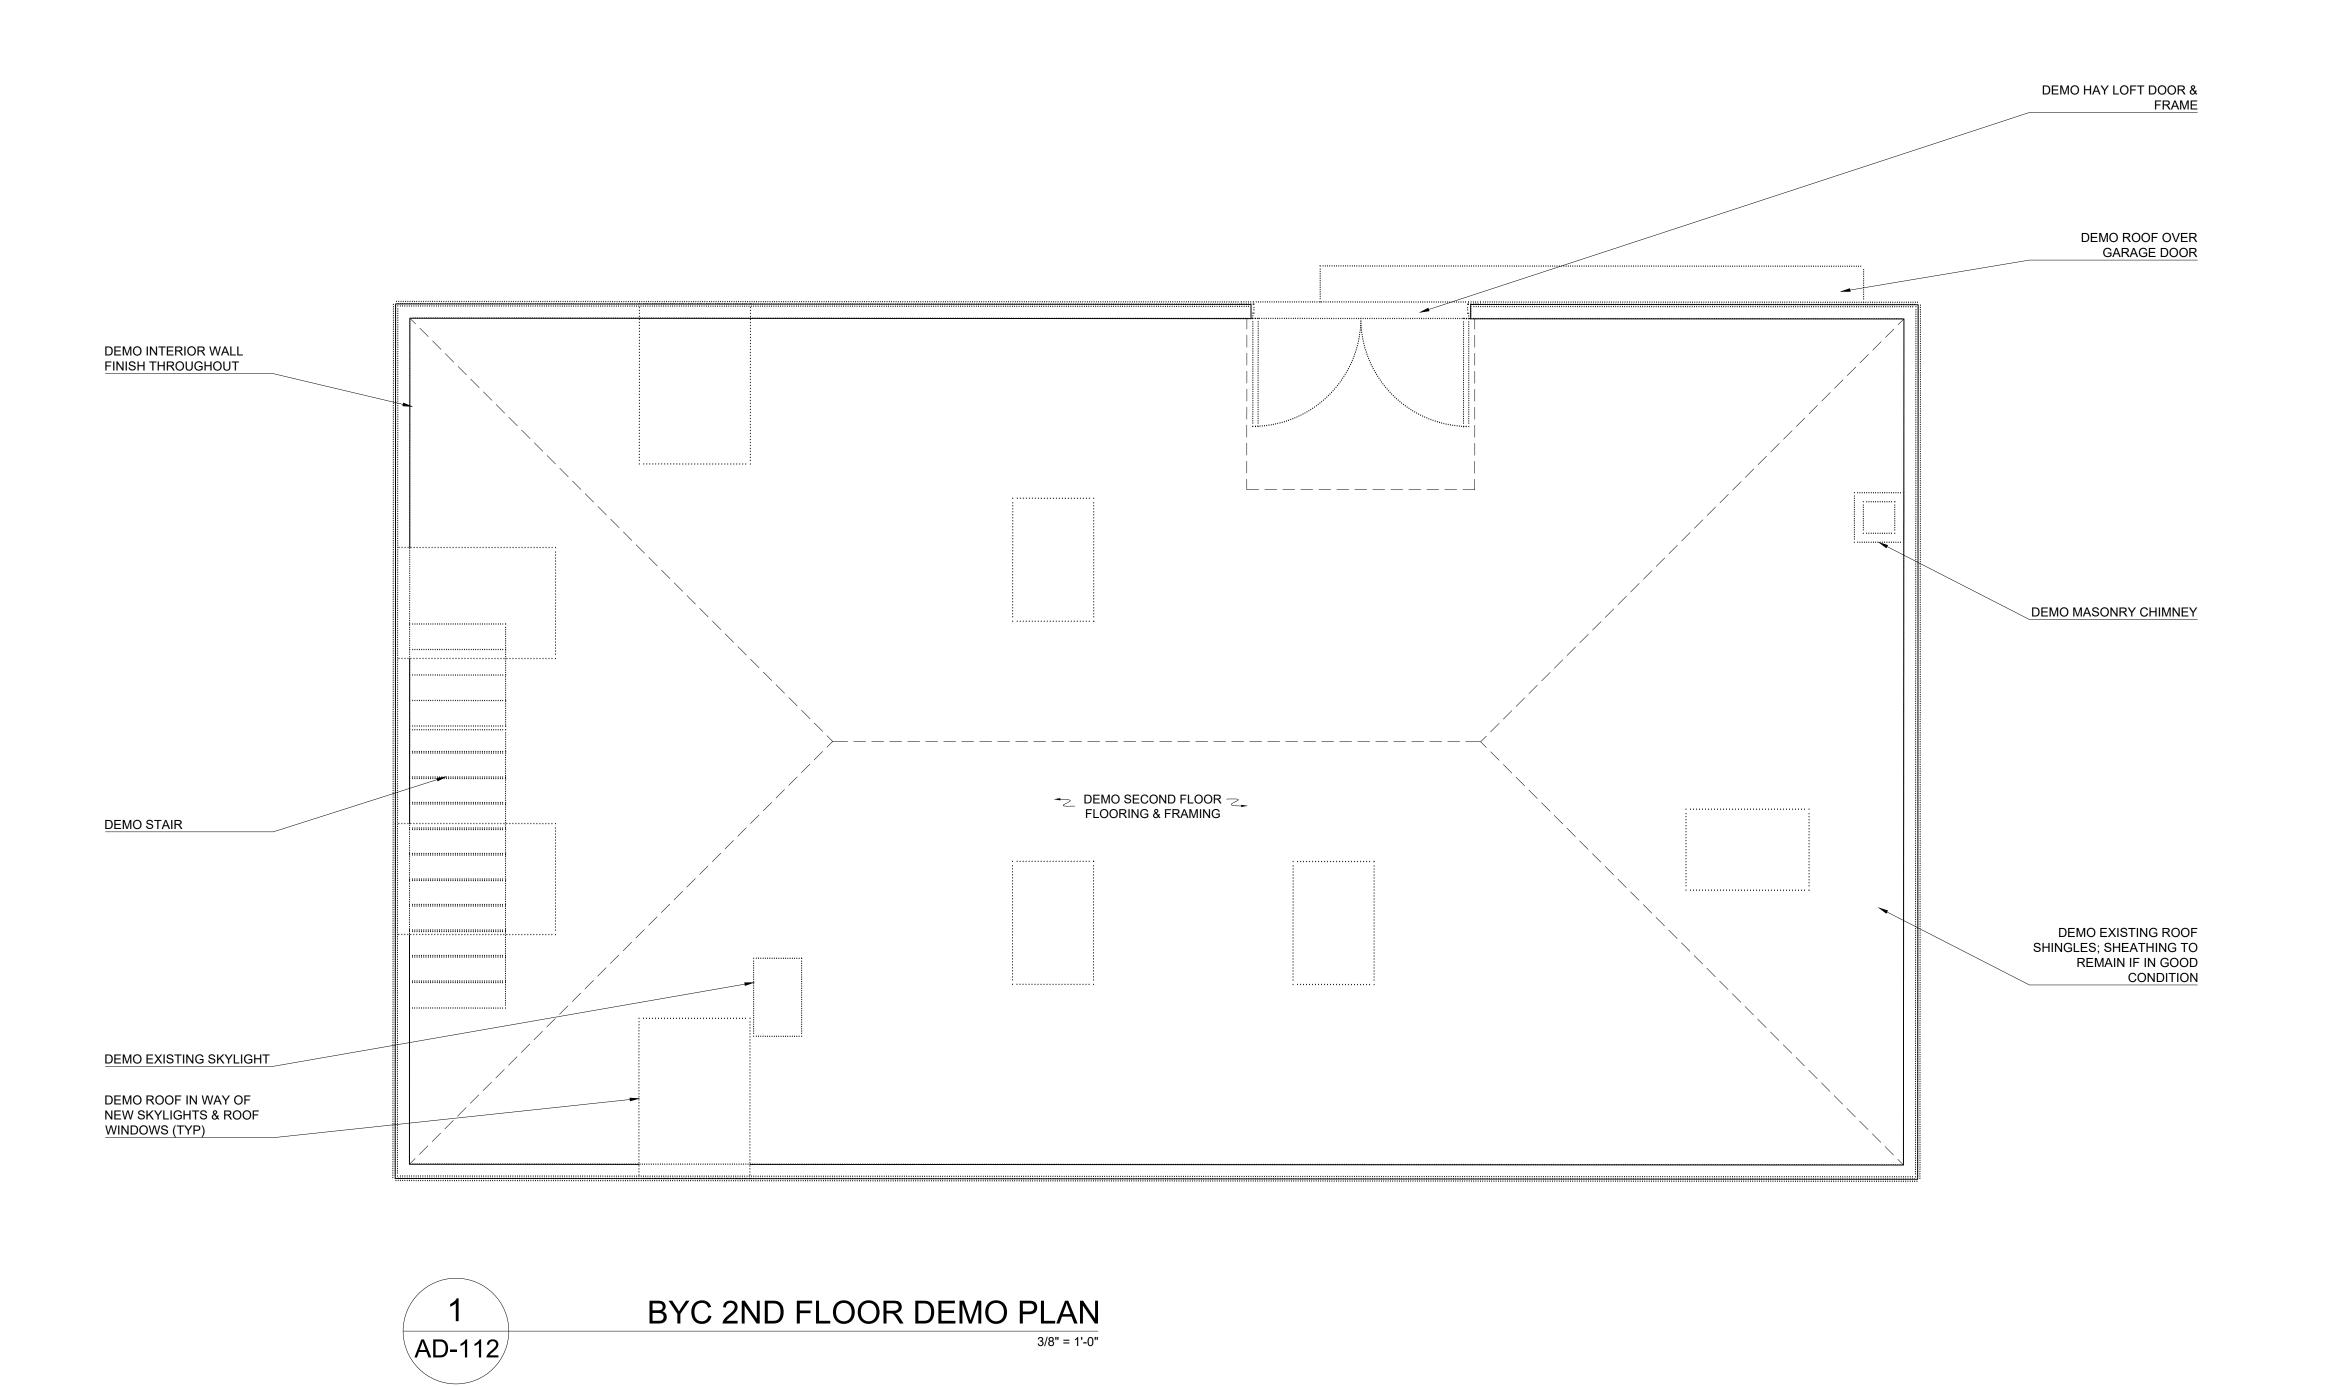
PROPOSED FLOOR PLANS
PROPOSED RESIDENTIAL RENOVATION
ZEPEDA & JONG RESIDENCE
21-23 FRANCESCA AVE.
SOMERVILLE, MA 02144


MAXWELL ARCHITECTS, LLC PLANNING / PROGRAMMING / DESIGN




PROJECT NUMBER: 202037 DRAWING NUMBER:

AD-112

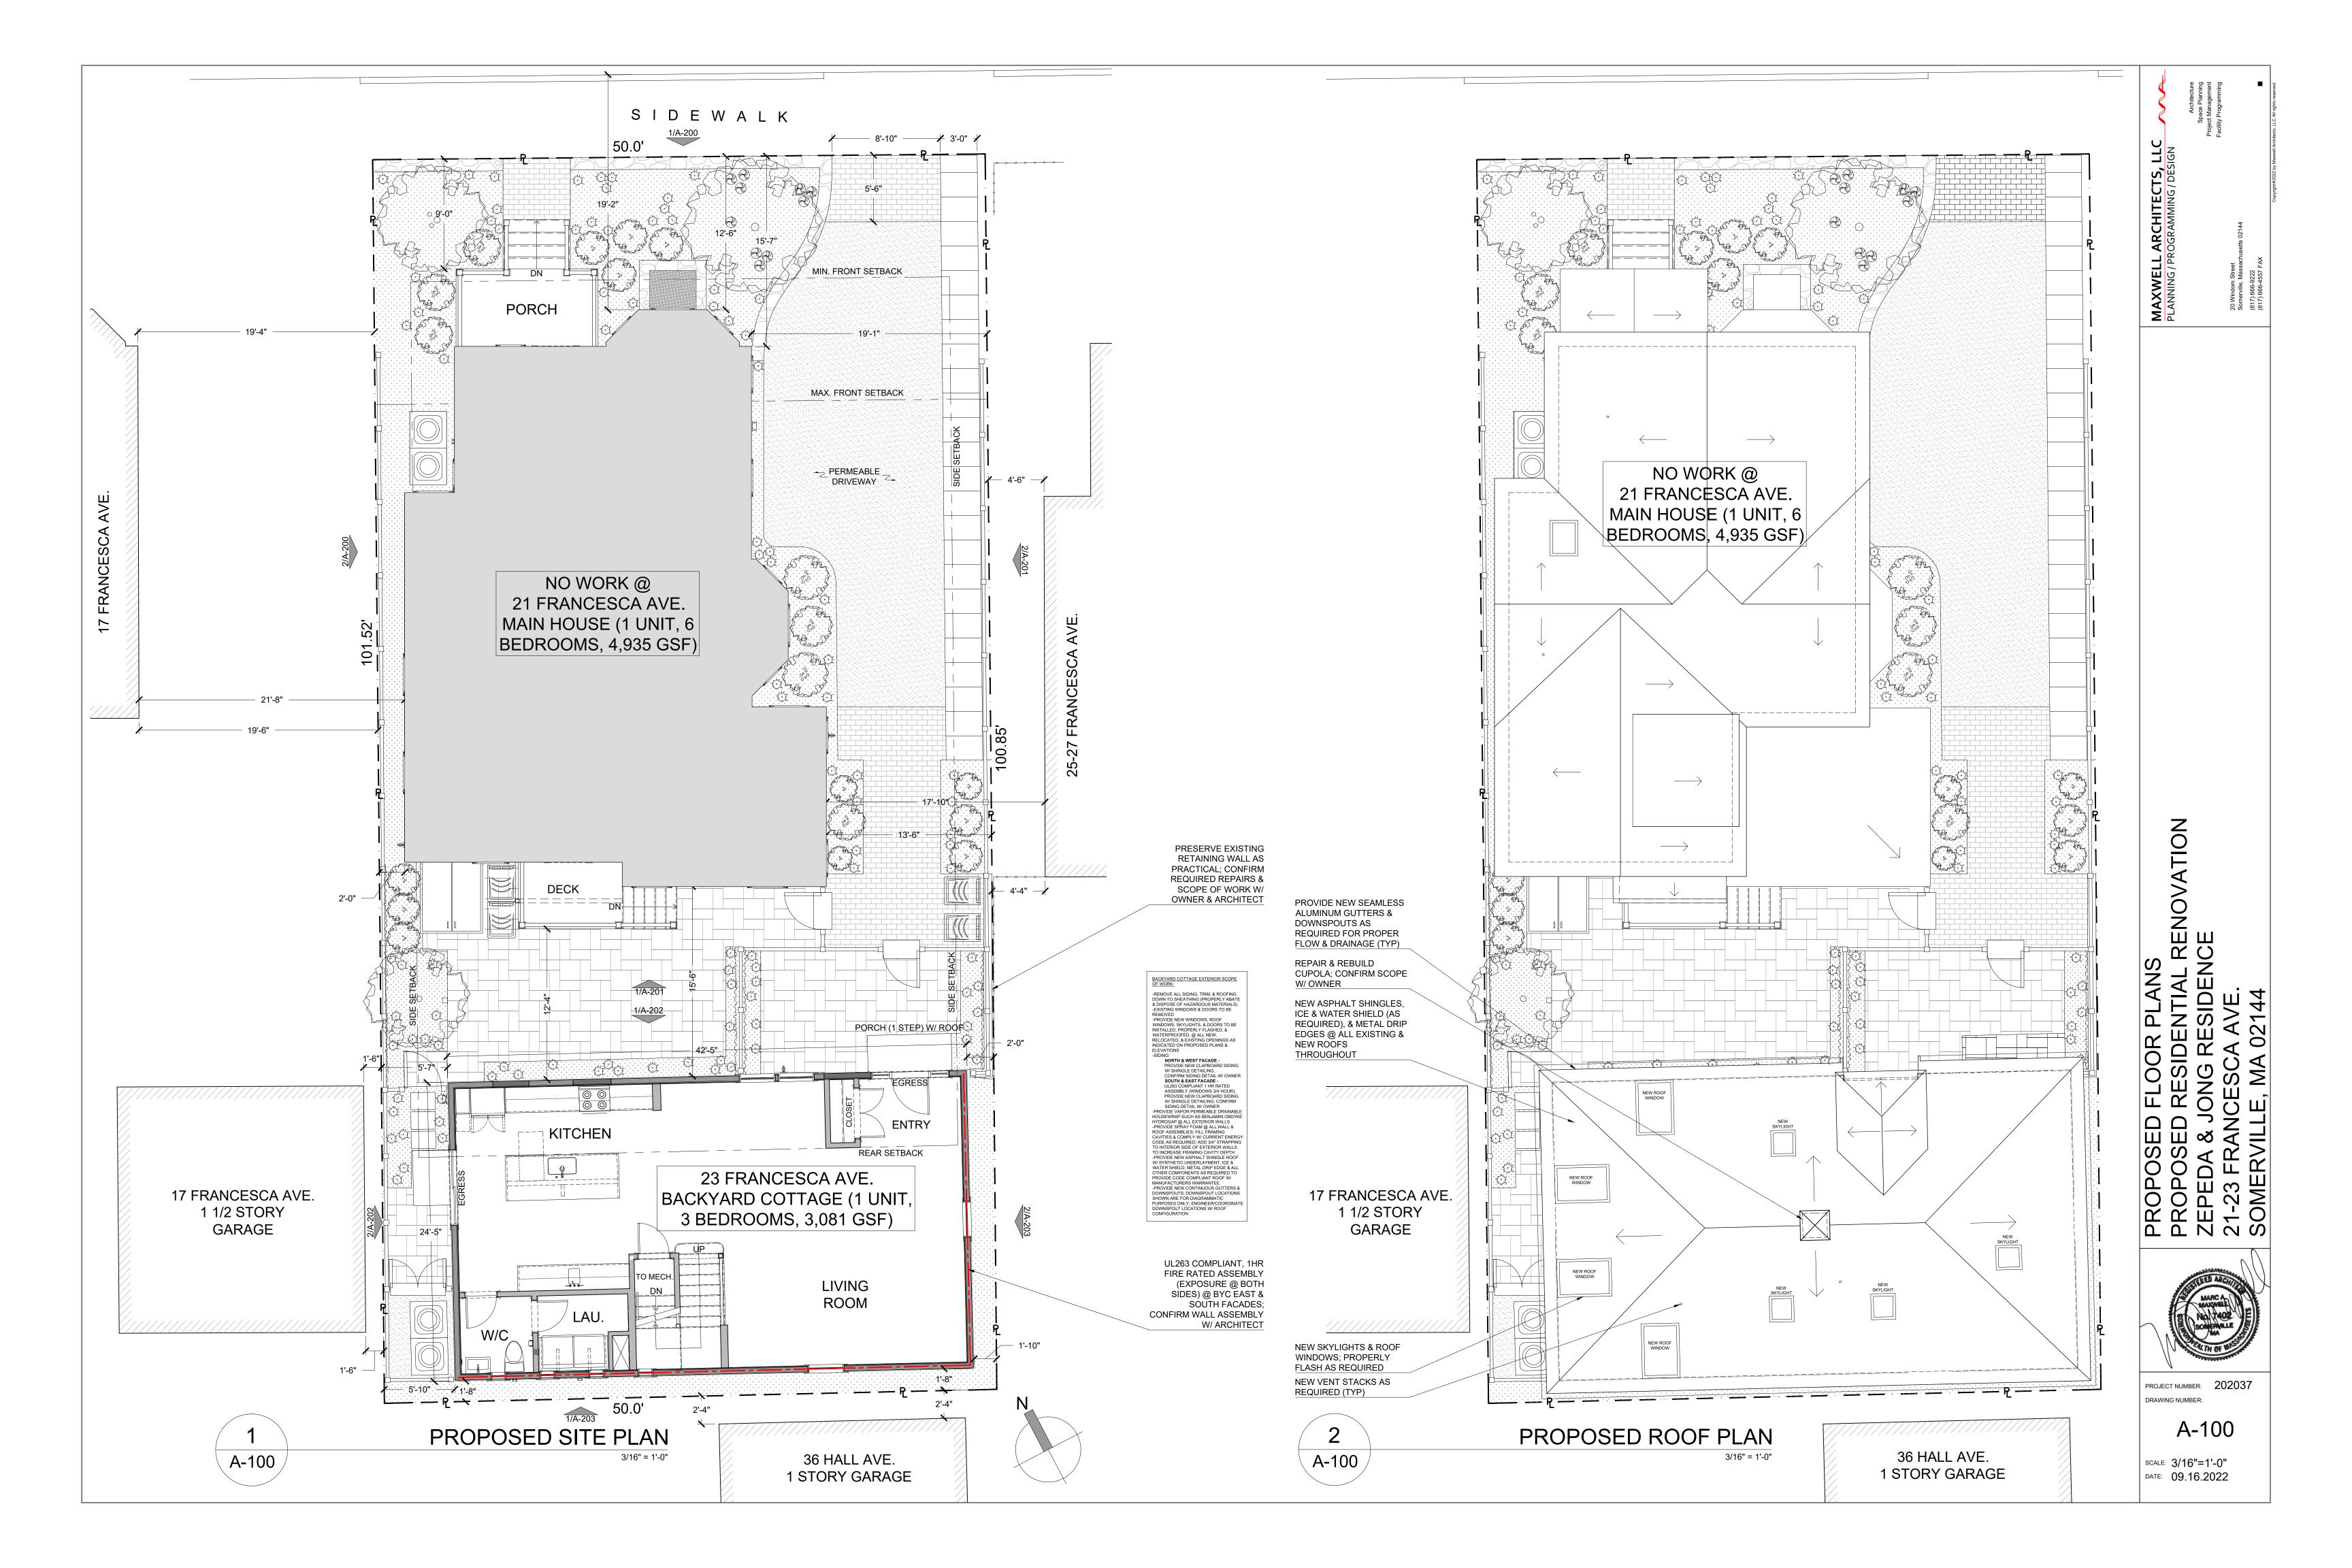

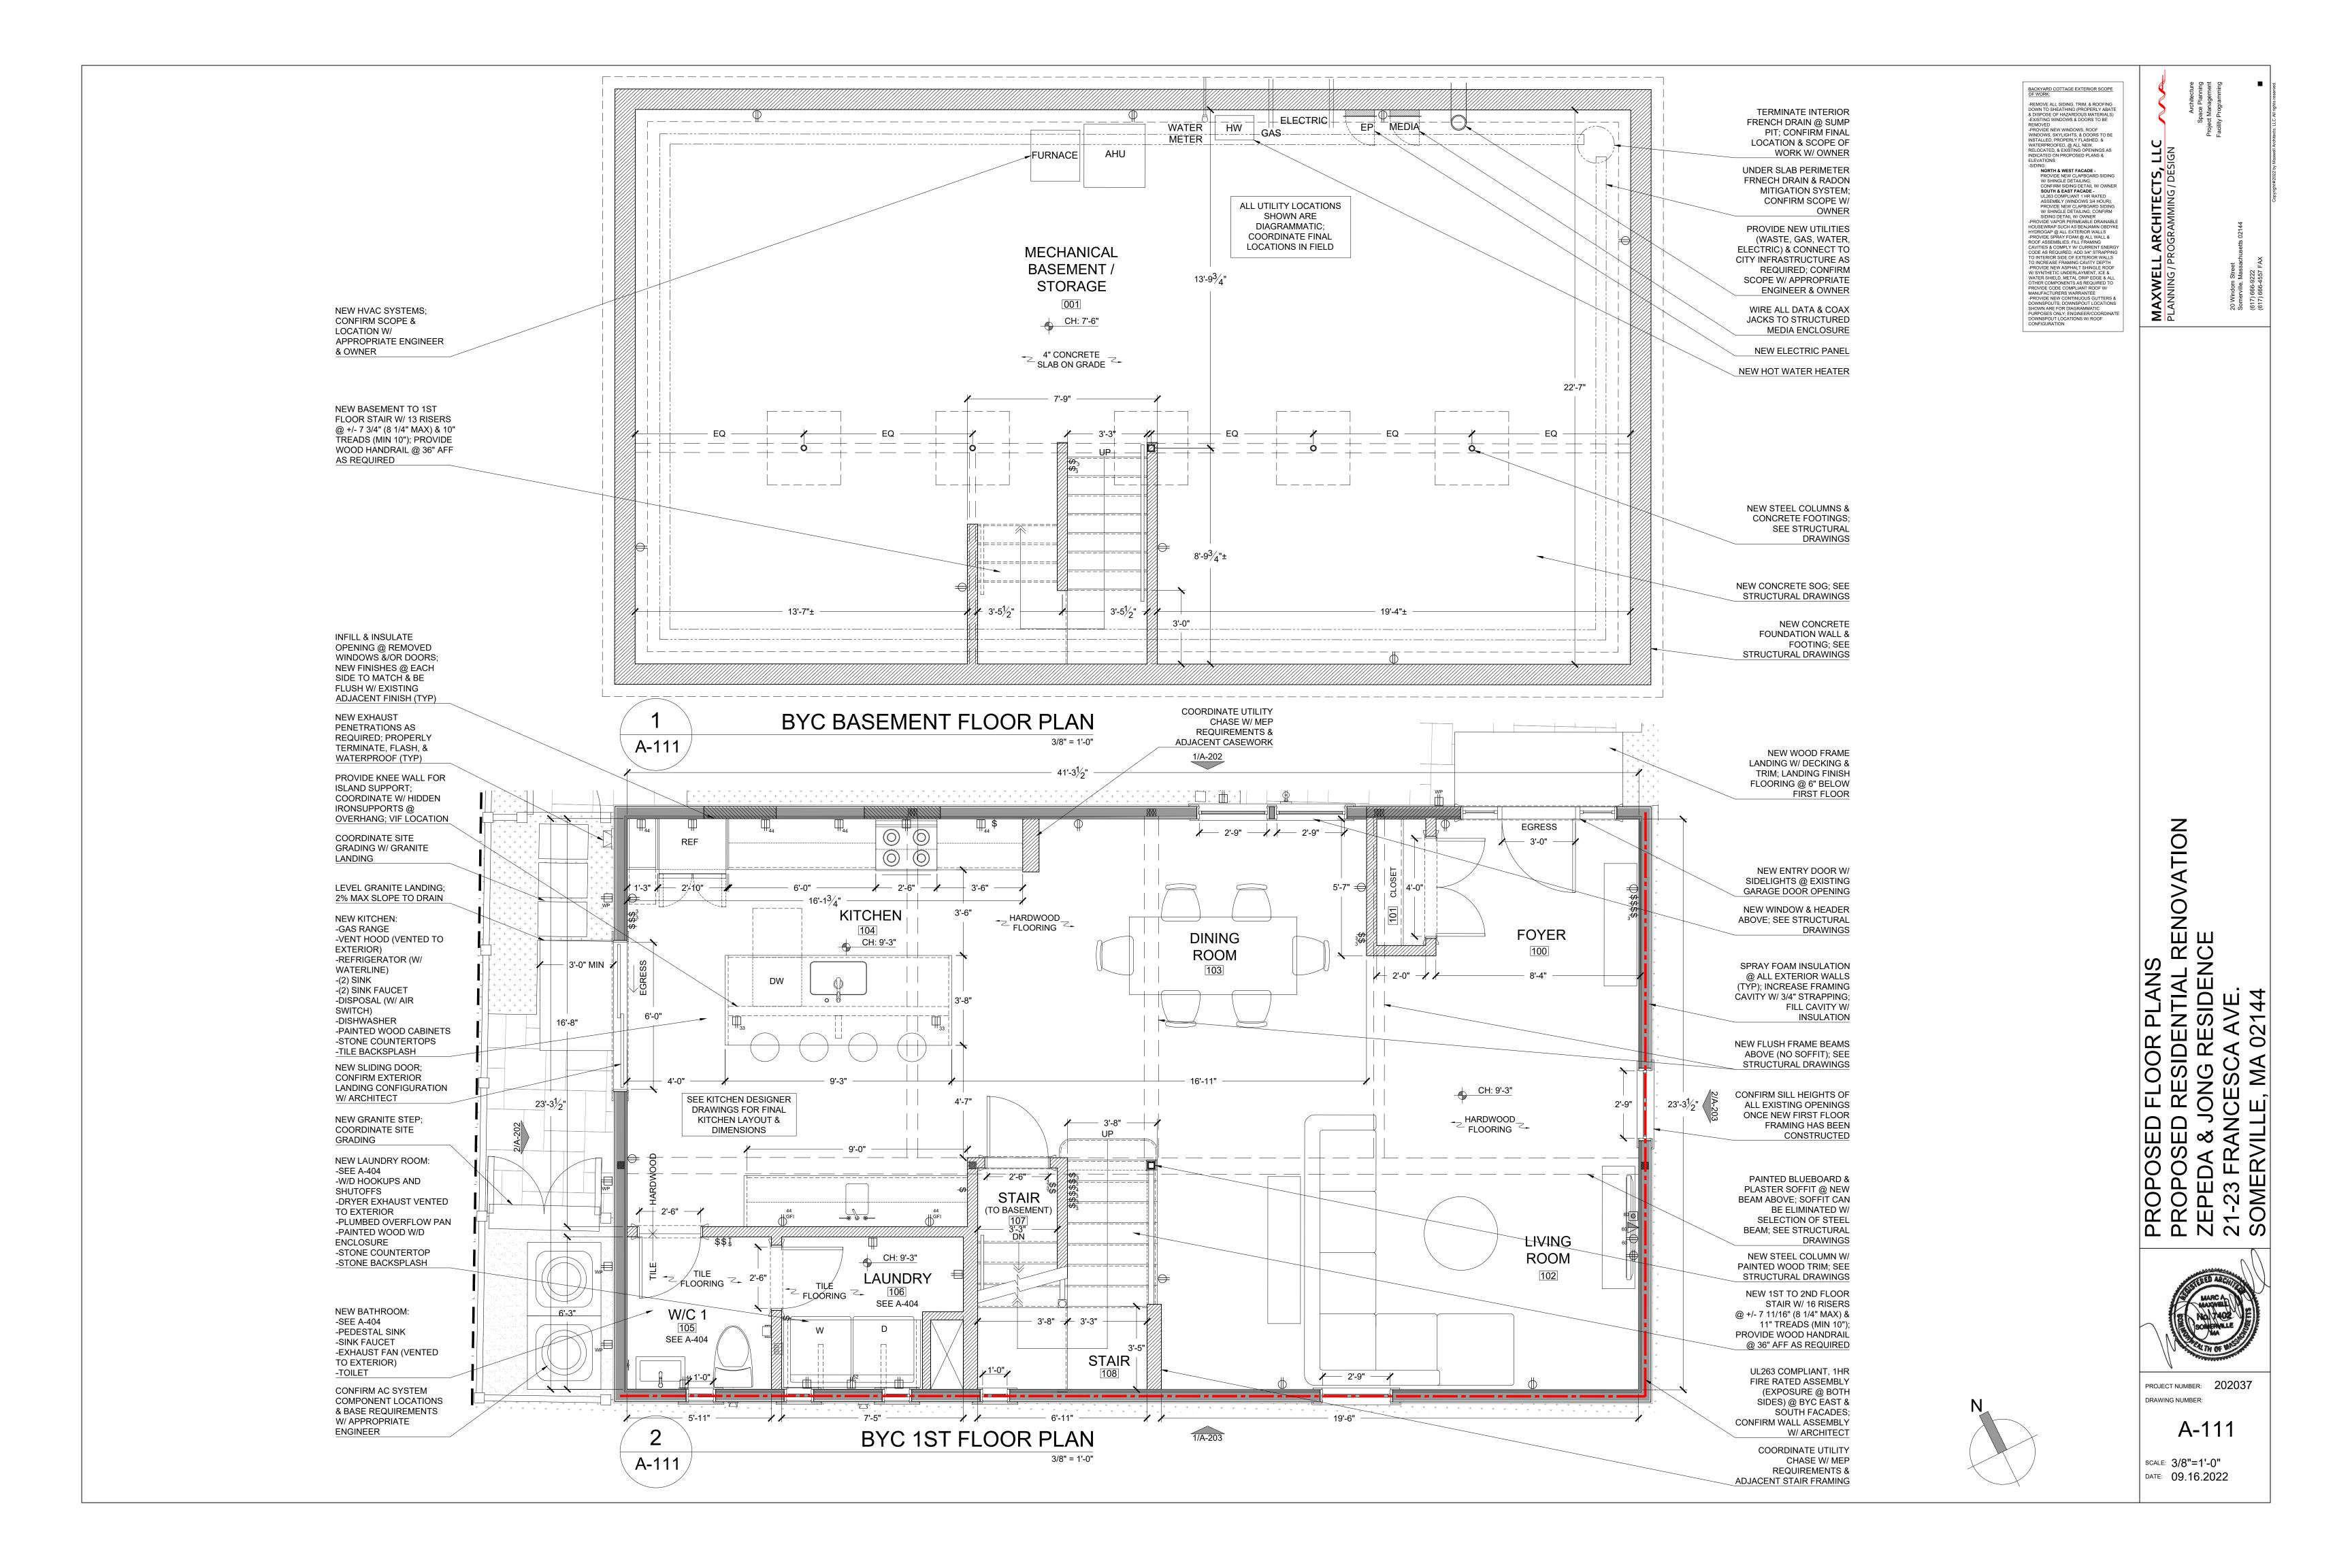

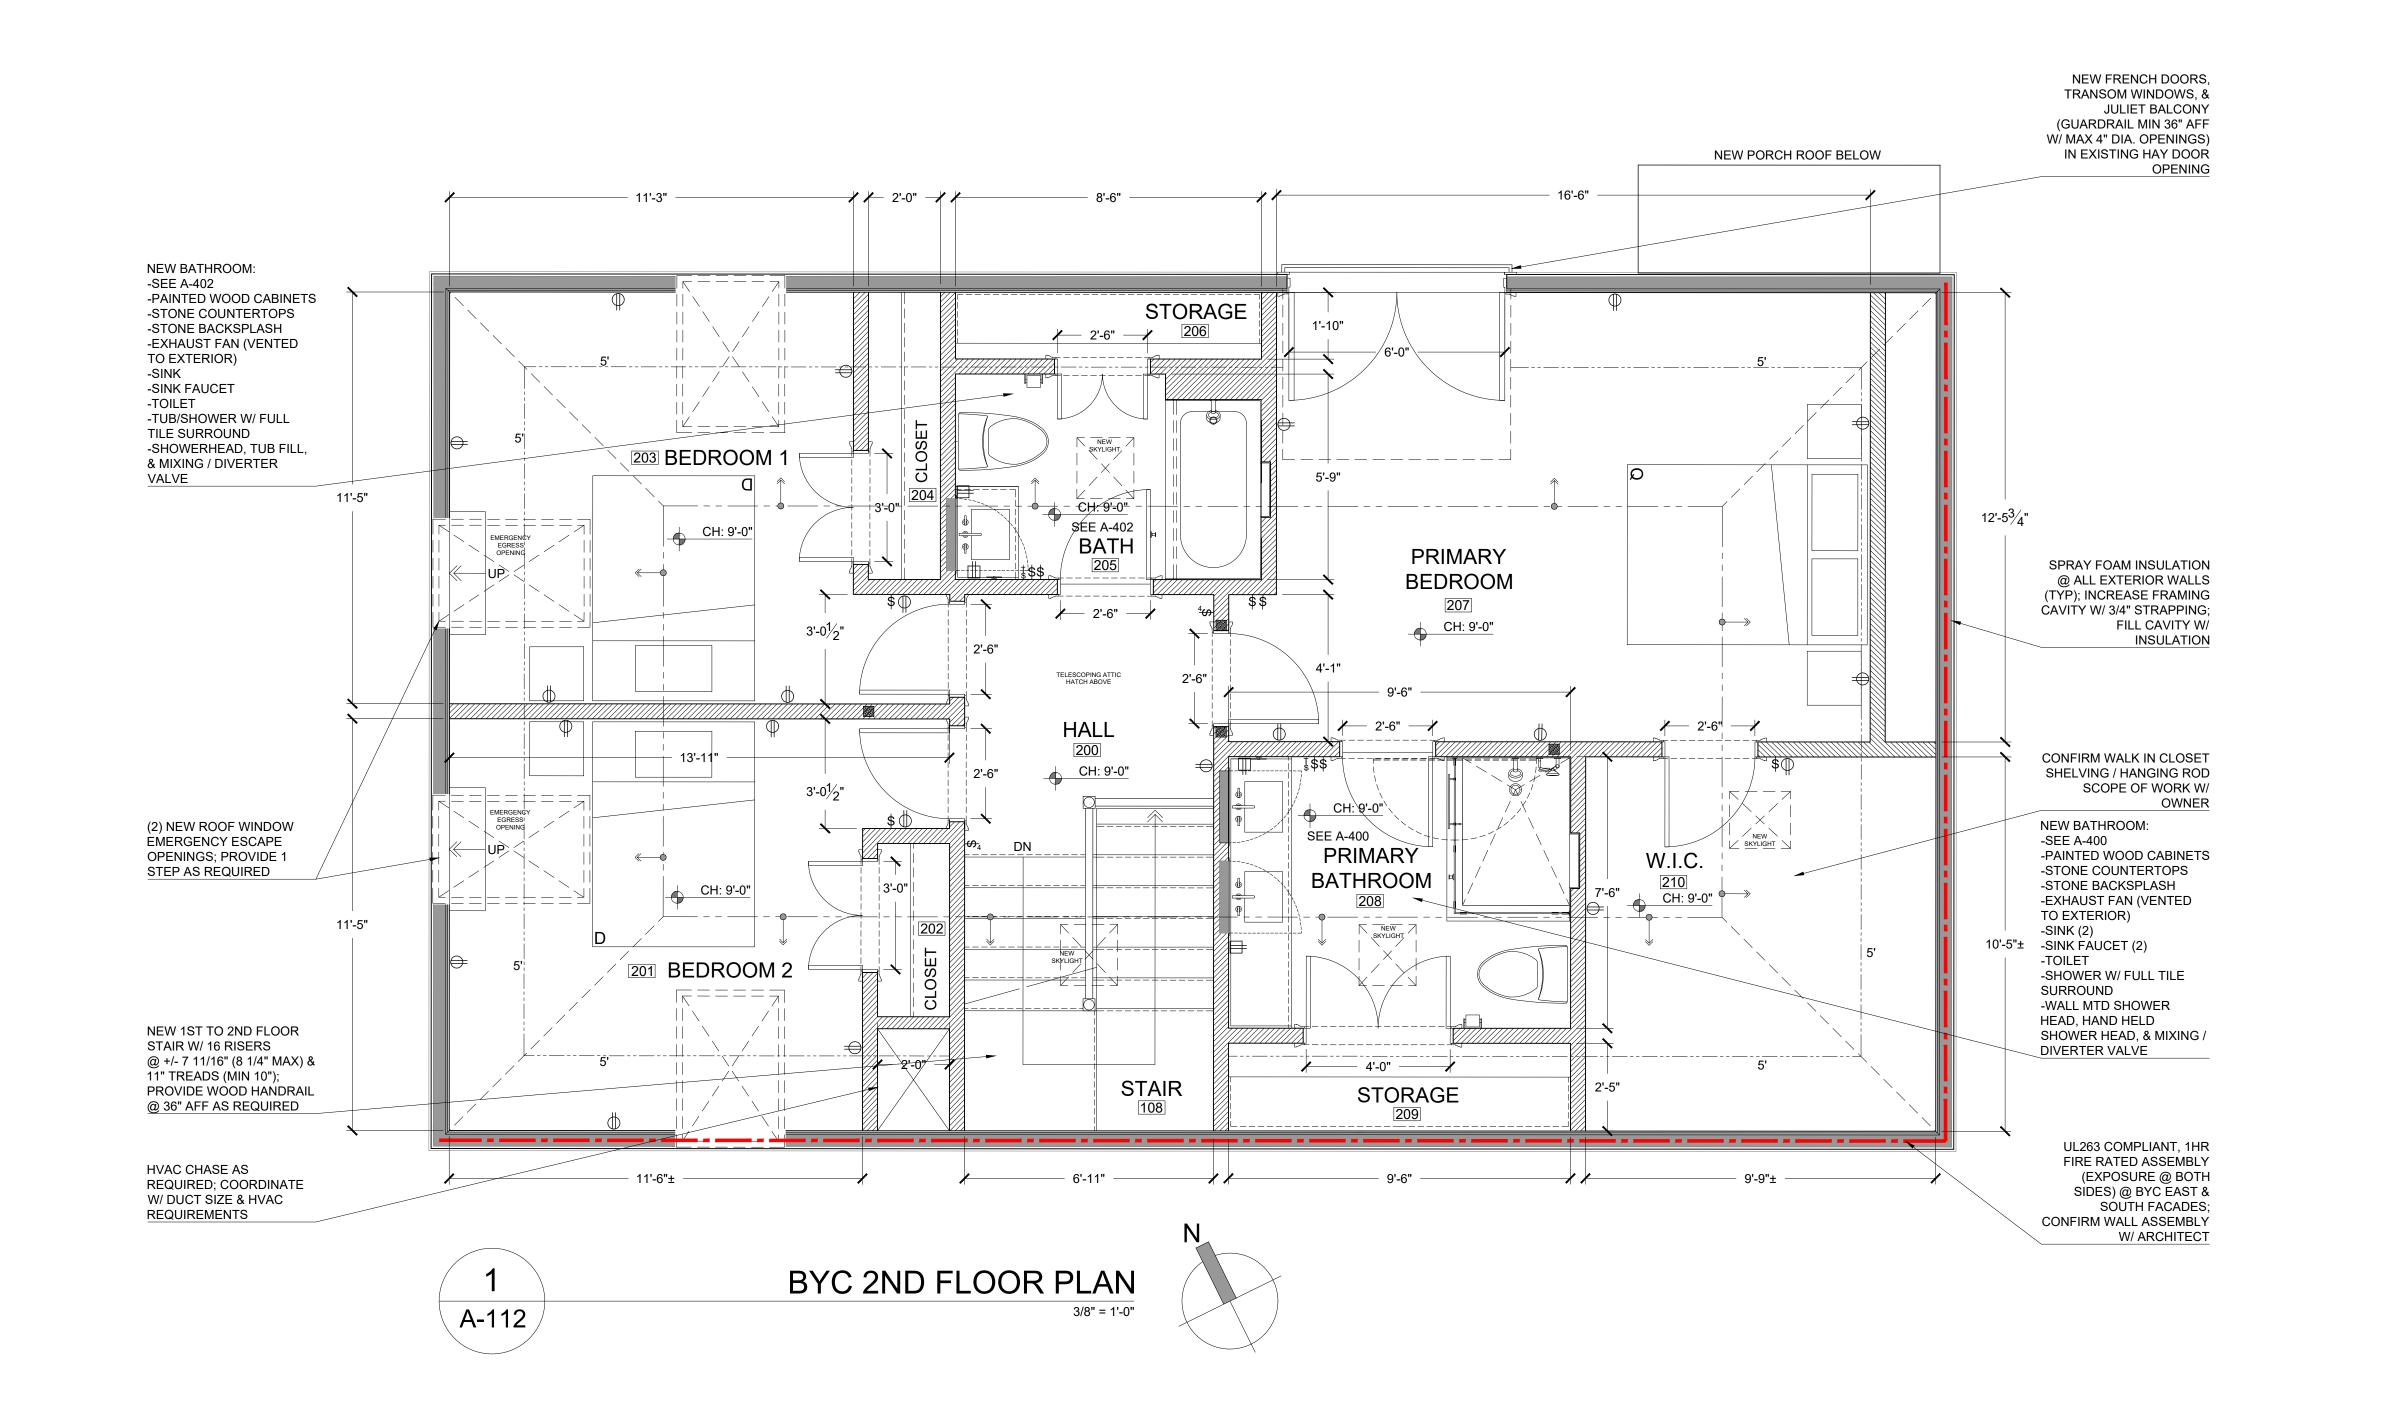

BACKYARD COTTAGE EXTERIOR SCOPE OF WORK:

EMERGENCY EGRESS OPENINGS

IF DOUBLE OR SINGLE HUNG:
- 3.3 SF MIN OPENING AREA
- 24\* & 20\* MIN OPENING DIMENSIONS
CAN BE IN EITHER DIRECTION
- 44\* MAX SILL HEIGHT

ANY OTHER APPROVED WINDOW TYPE:
-5.7 SF(5.0 SF IF BELOW GRADE) MIN
OPENING AREA
- 24" MIN OPENING HEIGHT
- 20" MIN OPENING WIDTH
- 44" MAX SILL HEIGHT

SEE IRC 2015 SECTION R310 & MA AMENDMENTS FOR REQUIREMENTS

EMERGENCY EGRESS WINDOW WELLS

- 36" MIN WIDTH & PROJECTION
- 9 SF MIN FOOTPRINT
- LADDER/STEPS NOT REQUIRED IF WELL
HEIGHT IS LESS THAN 44"
- TIE INTO FOUNDATION DRAINAGE
SYSTEM OR APPROVED ALTERNATE
- 36" MIN HEAD HEIGHT ABOVE WELL


. ARCHITECTS, I ROGRAMMING/DESI

PROPOSED FLOOR PLANS
PROPOSED RESIDENTIAL RENOVATION
ZEPEDA & JONG RESIDENCE
21-23 FRANCESCA AVE.
SOMERVILLE, MA 02144




PROJECT NUMBER: 202037 DRAWING NUMBER:

A-112

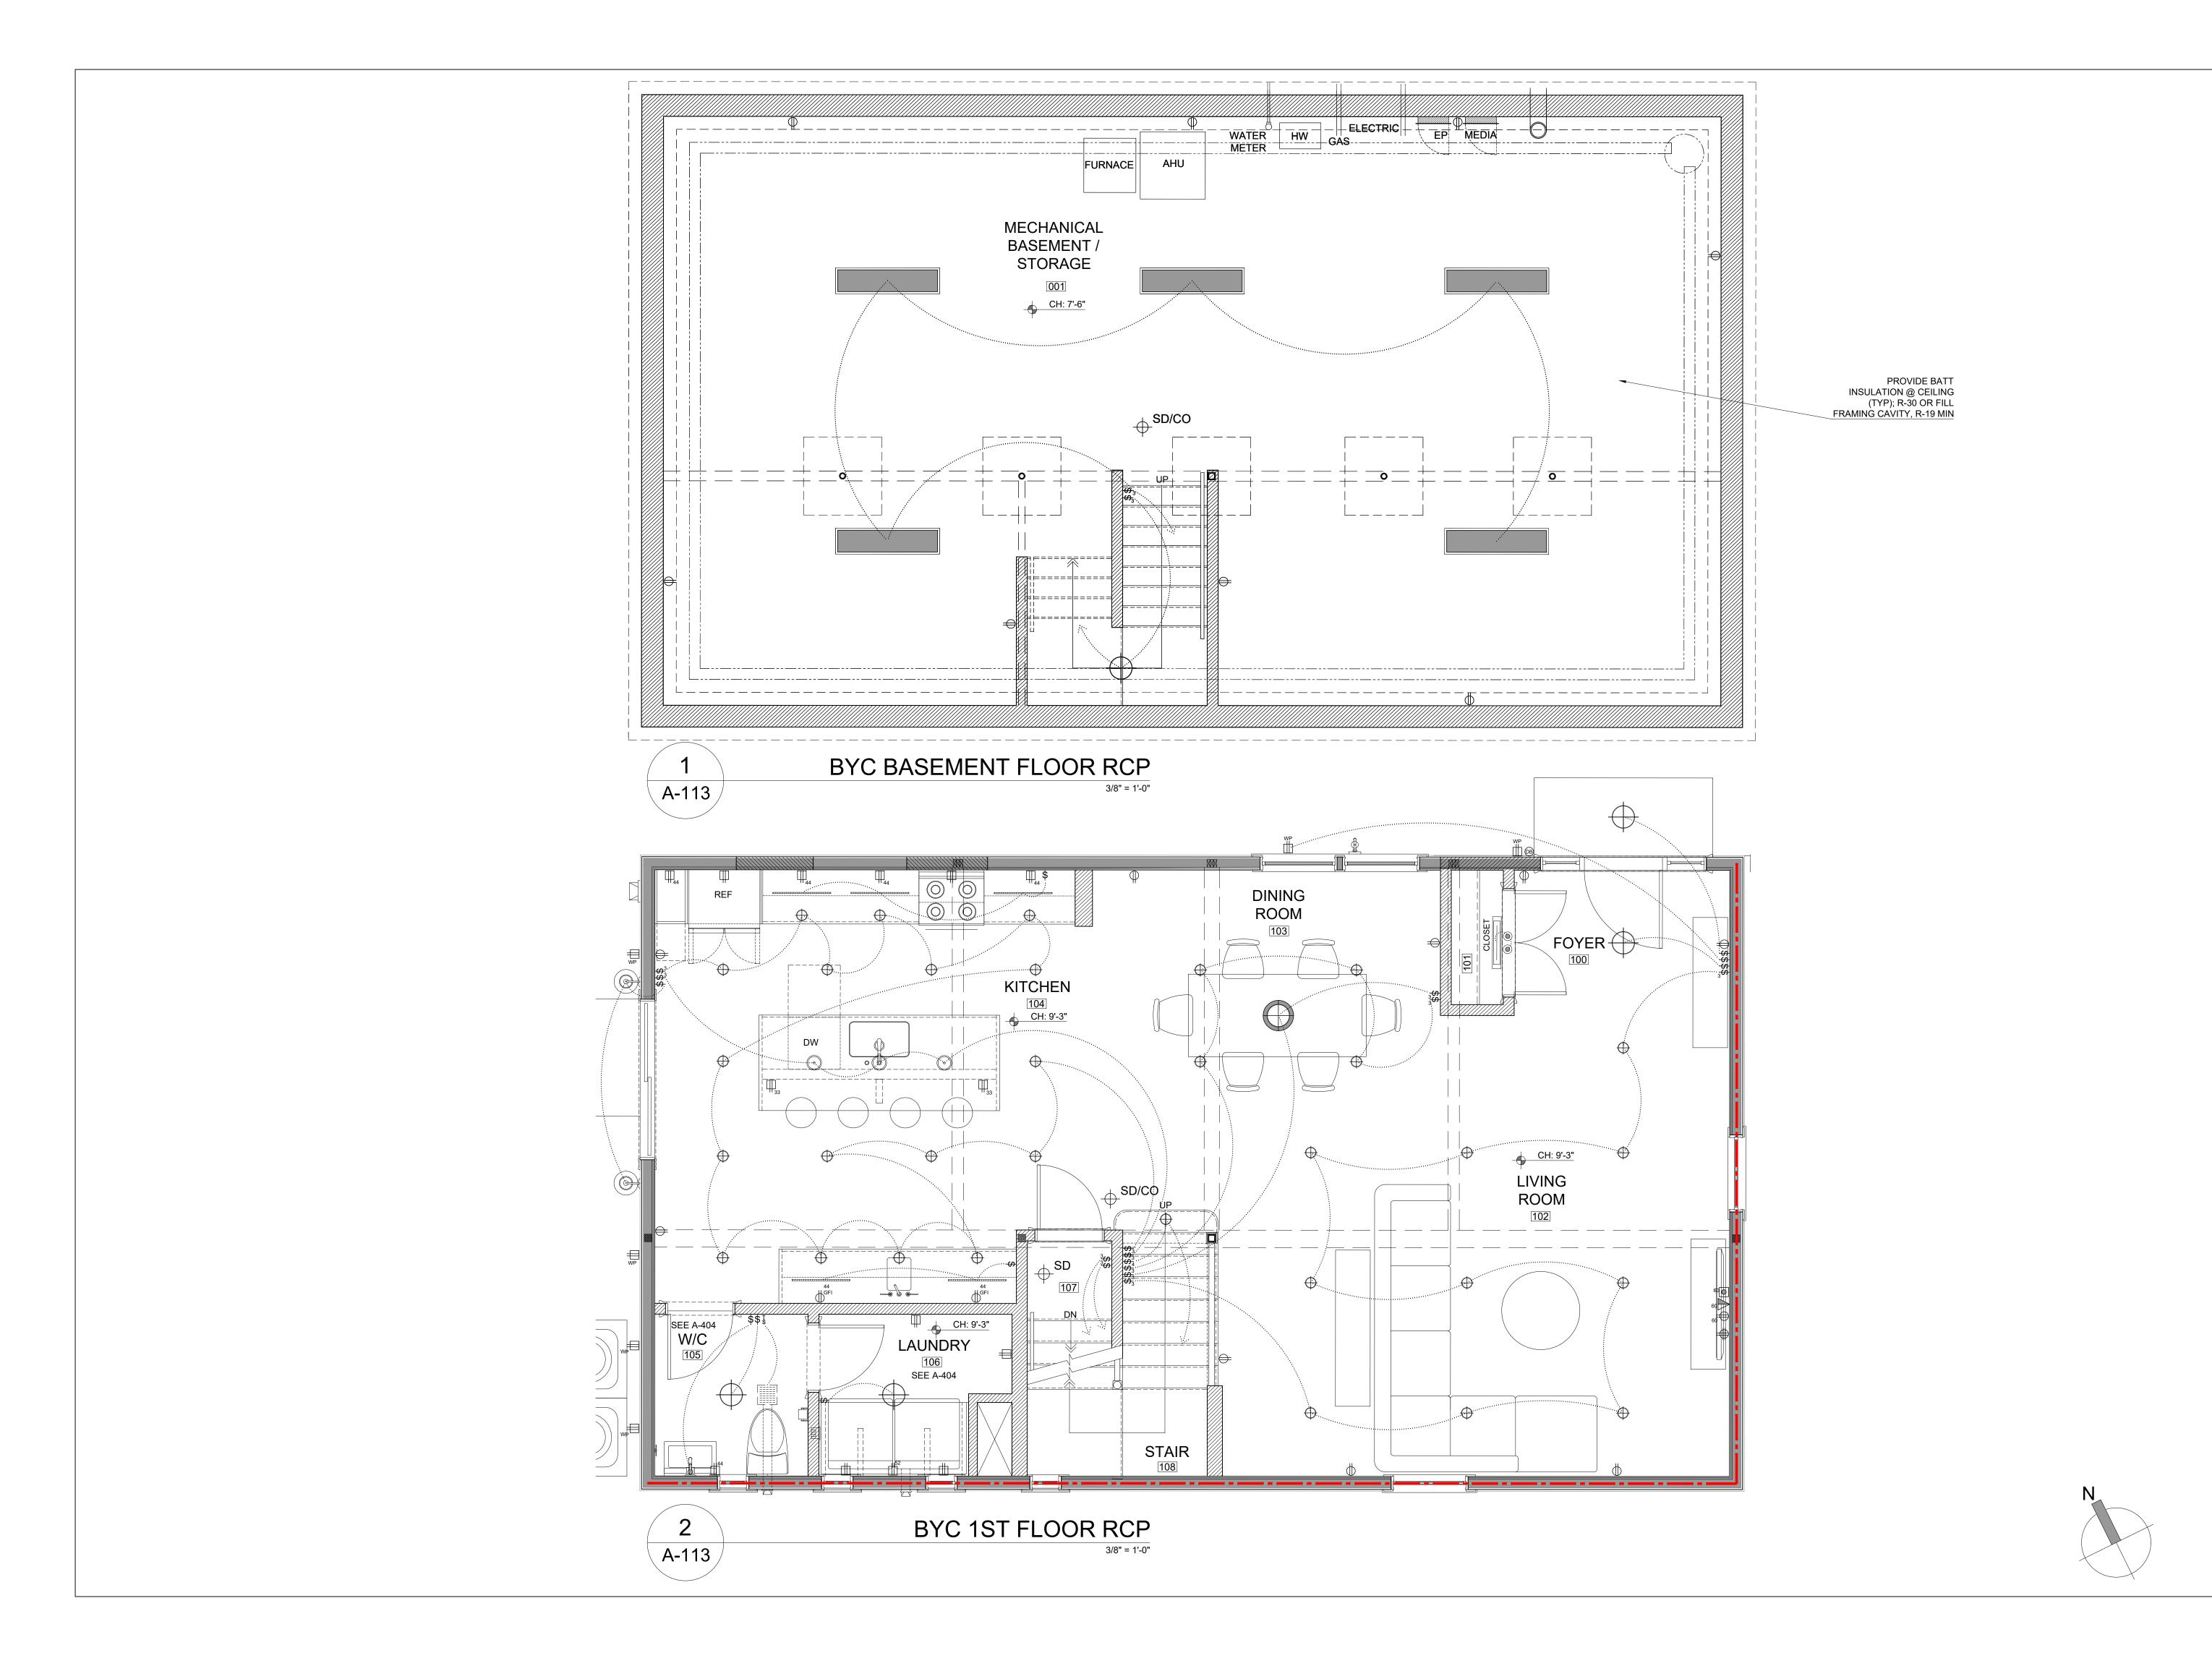





PROPOSED REFLECTED CEILING PLANS PROPOSED RESIDENTIAL RENOVATION ZEPEDA & JONG RESIDENCE 21-23 FRANCESCA AVE. SOMERVILLE, MA 02144

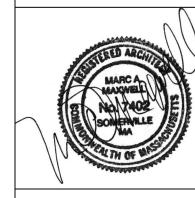

PROJECT NUMBER: 202037
DRAWING NUMBER:


A-113

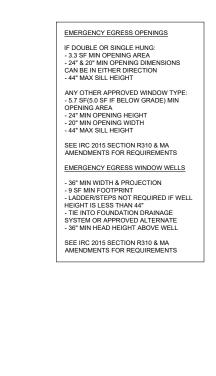

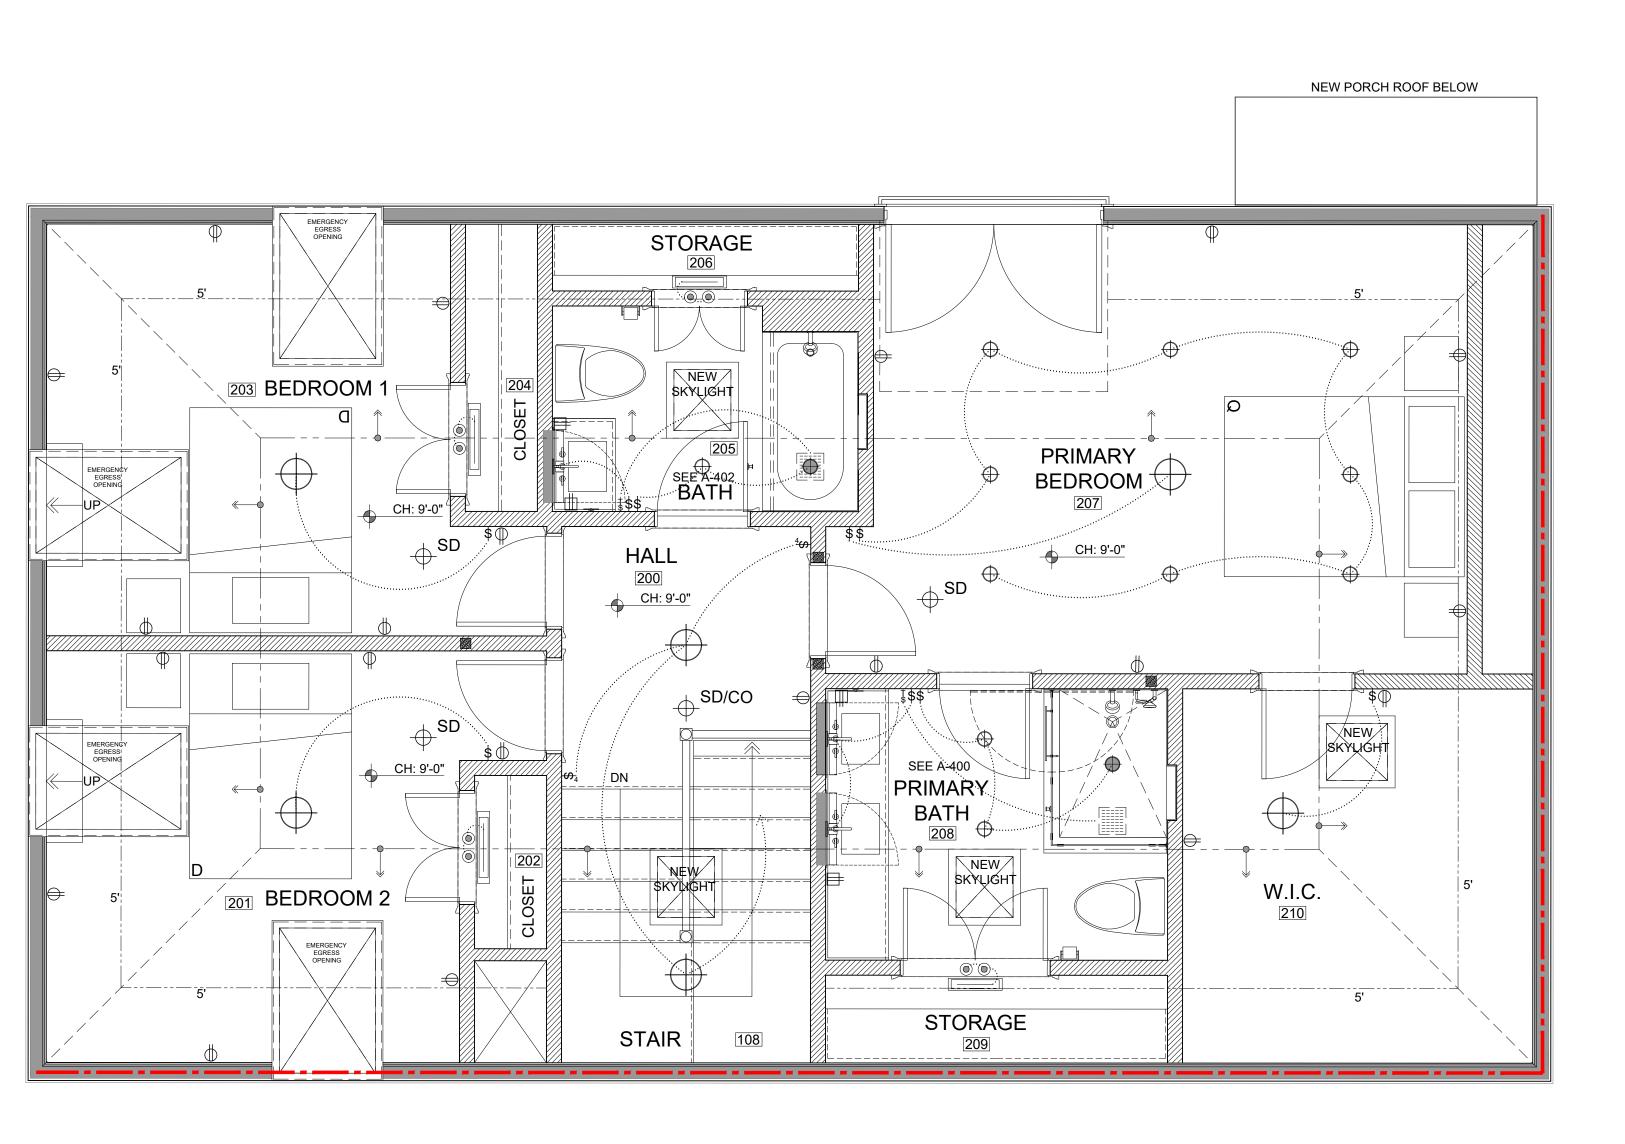


A-114

BYC 2ND FLOOR RCP

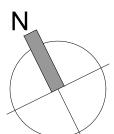


PROPOSED REFLECTED CEILING PLANS PROPOSED RESIDENTIAL RENOVATION ZEPEDA & JONG RESIDENCE 21-23 FRANCESCA AVE. SOMERVILLE, MA 02144

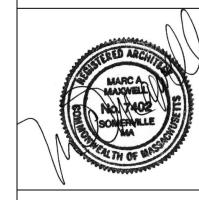

PROJECT NUMBER: 202037


DRAWING NUMBER:

A-114

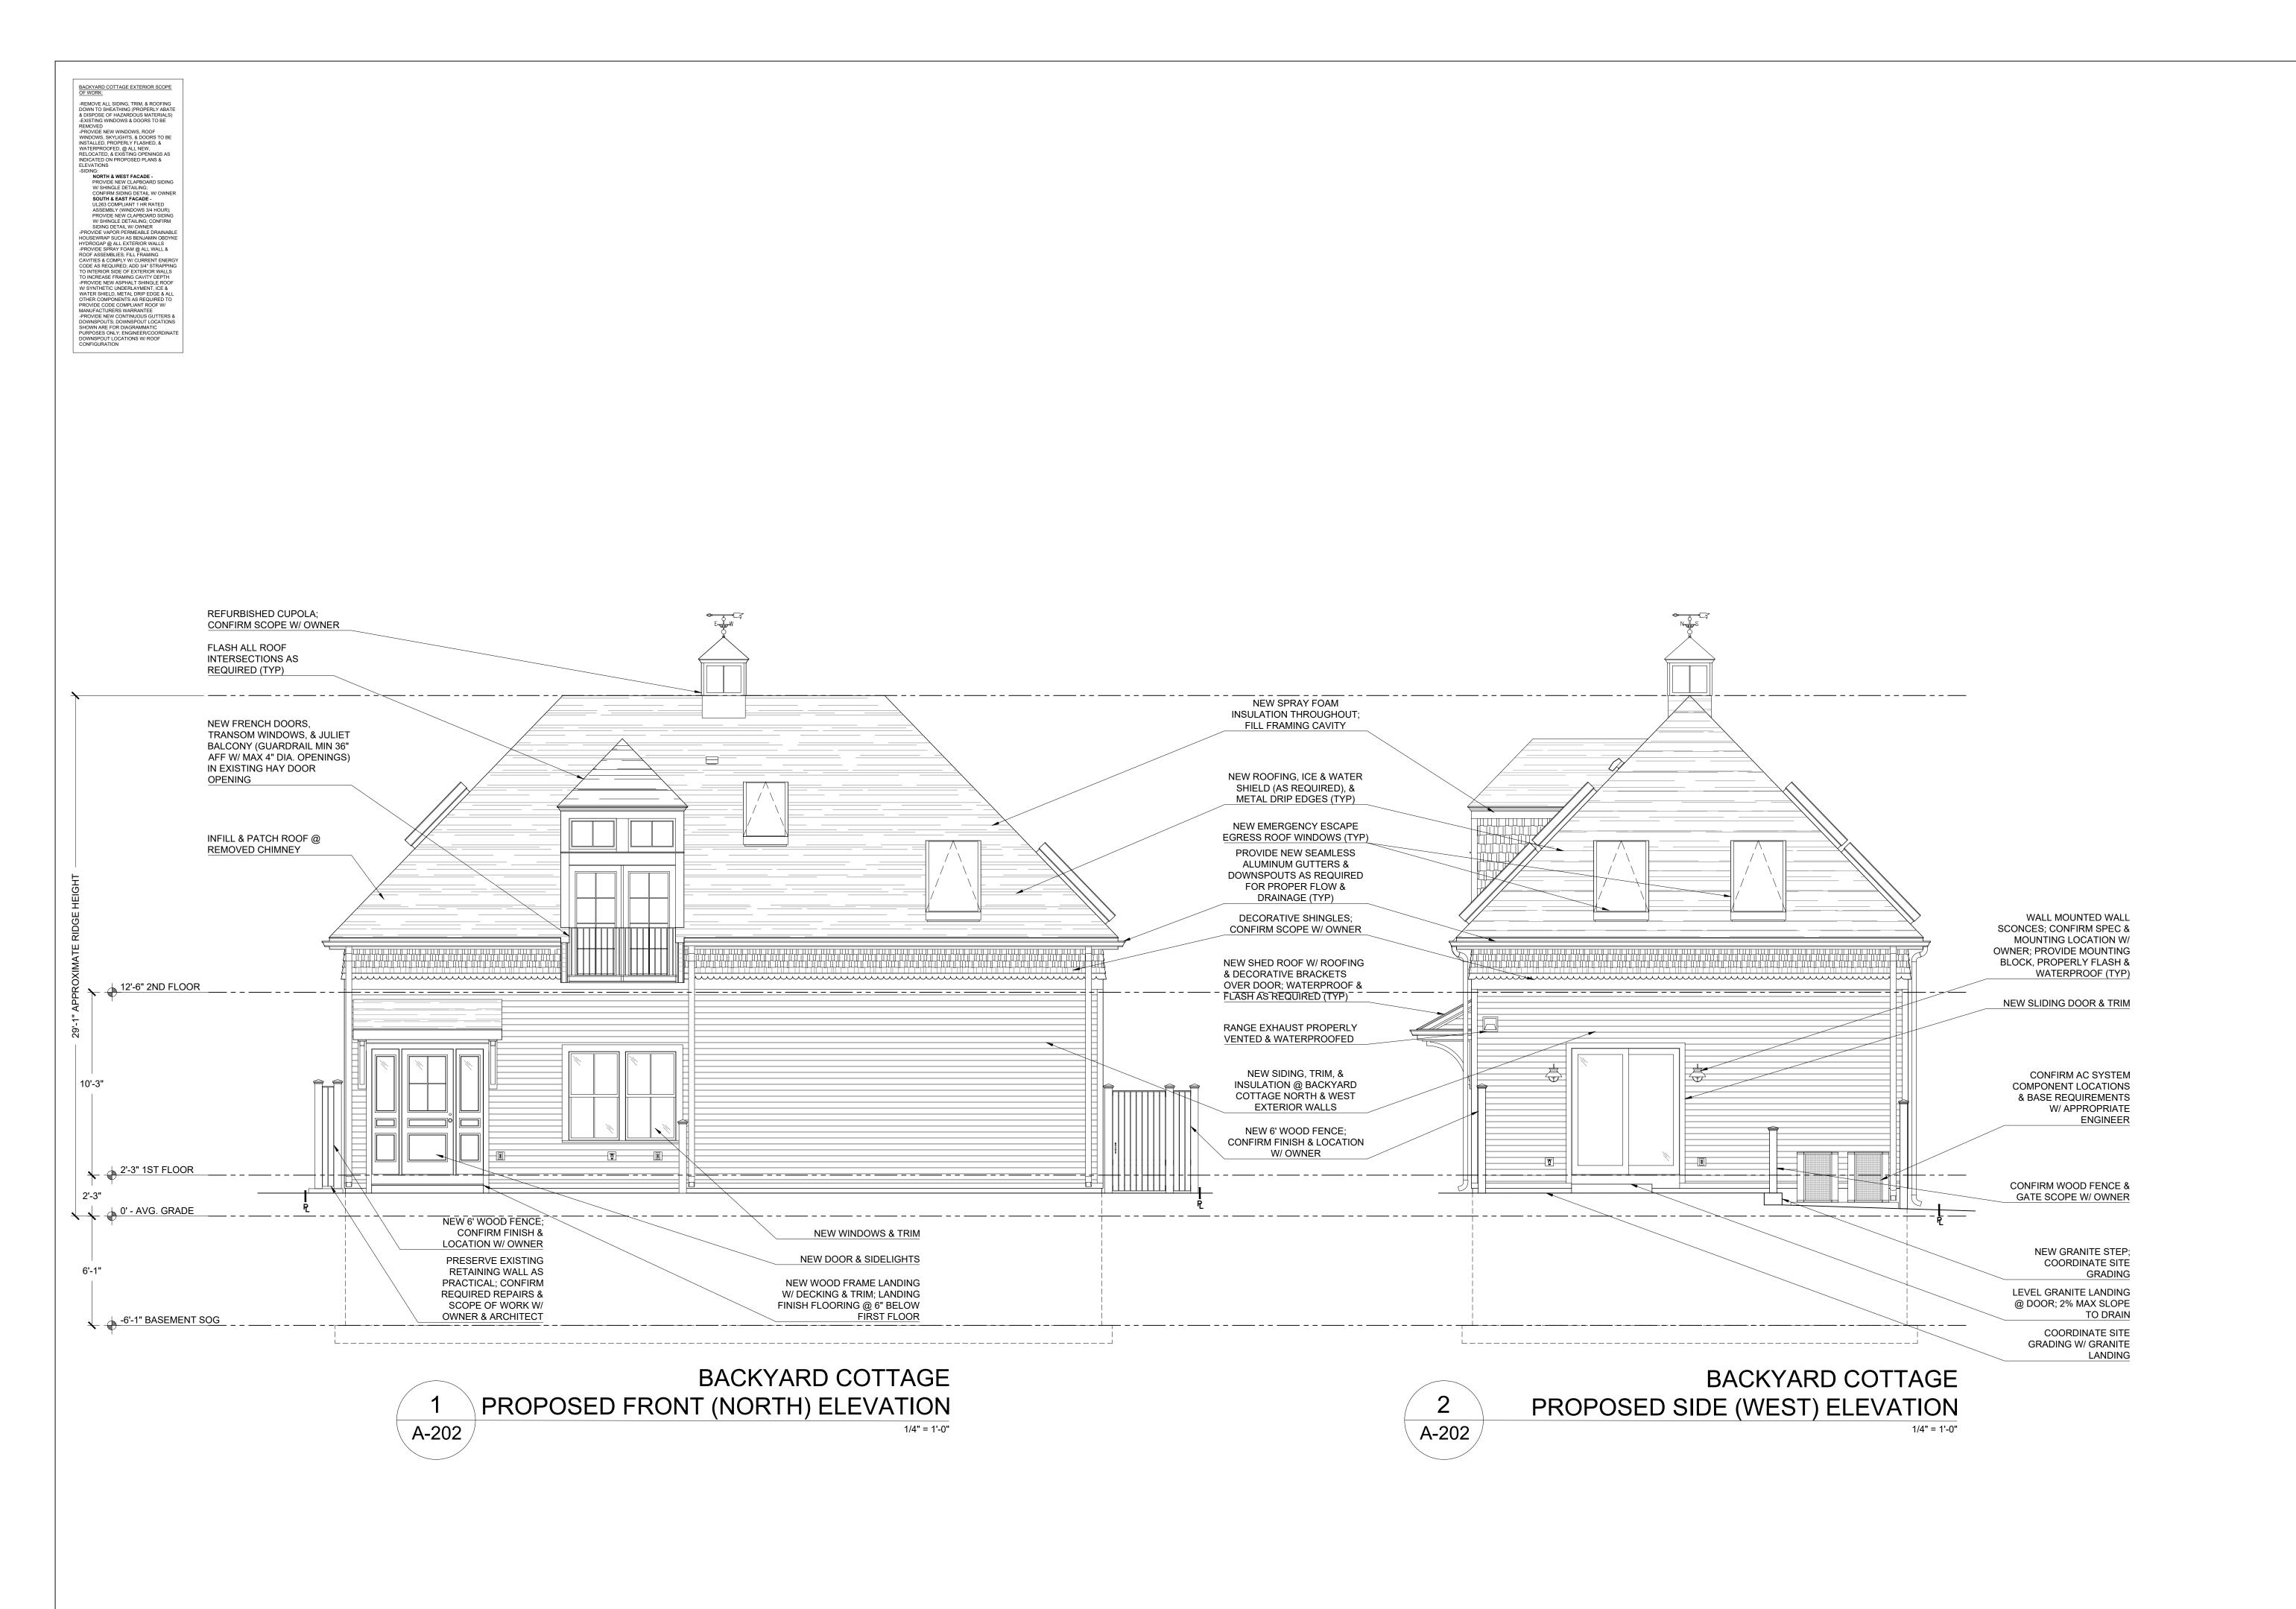

PROPOSED BACKYARD COTTAGE ELEVATIONS PROPOSED RESIDENTIAL RENOVATION ZEPEDA & JONG RESIDENCE 21-23 FRANCESCA AVE. SOMERVILLE, MA 02144

MAXWELL A

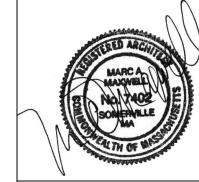

PROJECT NUMBER: 202037
DRAWING NUMBER:

A-202





PROPOSED BACKYARD COTTAGE ELEVATIONS
PROPOSED RESIDENTIAL RENOVATION
ZEPEDA & JONG RESIDENCE
21-23 FRANCESCA AVE.
SOMERVILLE, MA 02144

MARC A MAJOVELL NO. 17402 E SONIENVILLE SO

PROJECT NUMBER: 202037
DRAWING NUMBER:

A-203

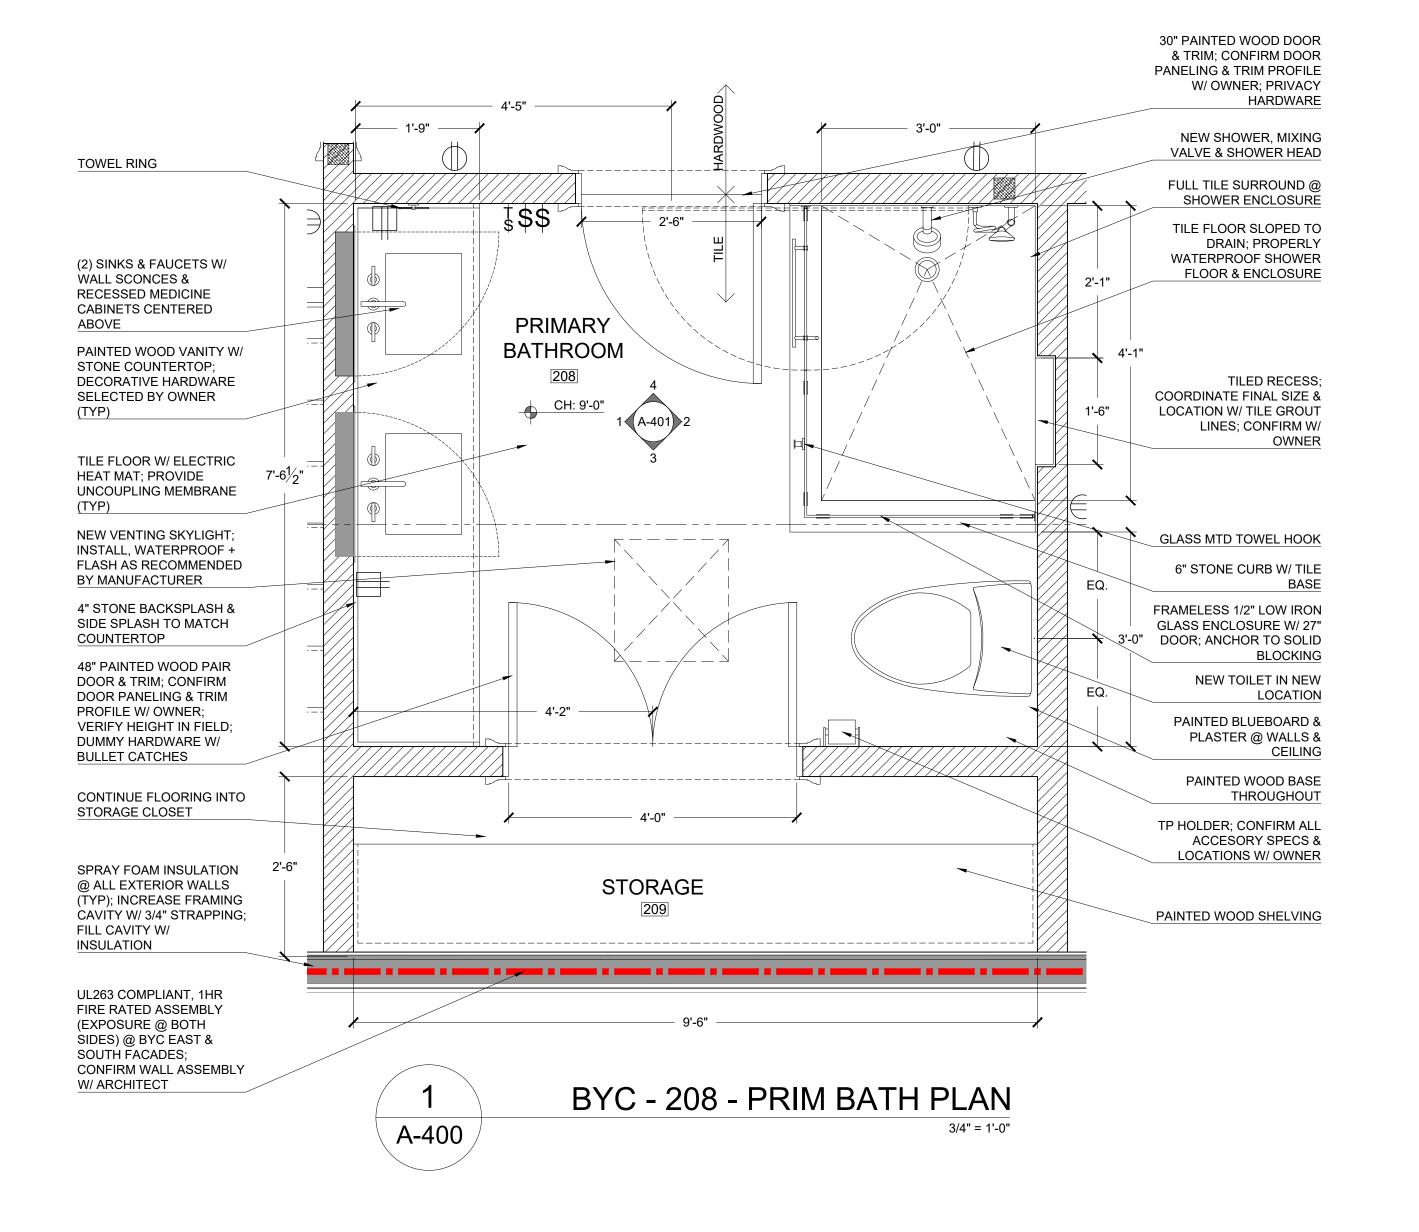

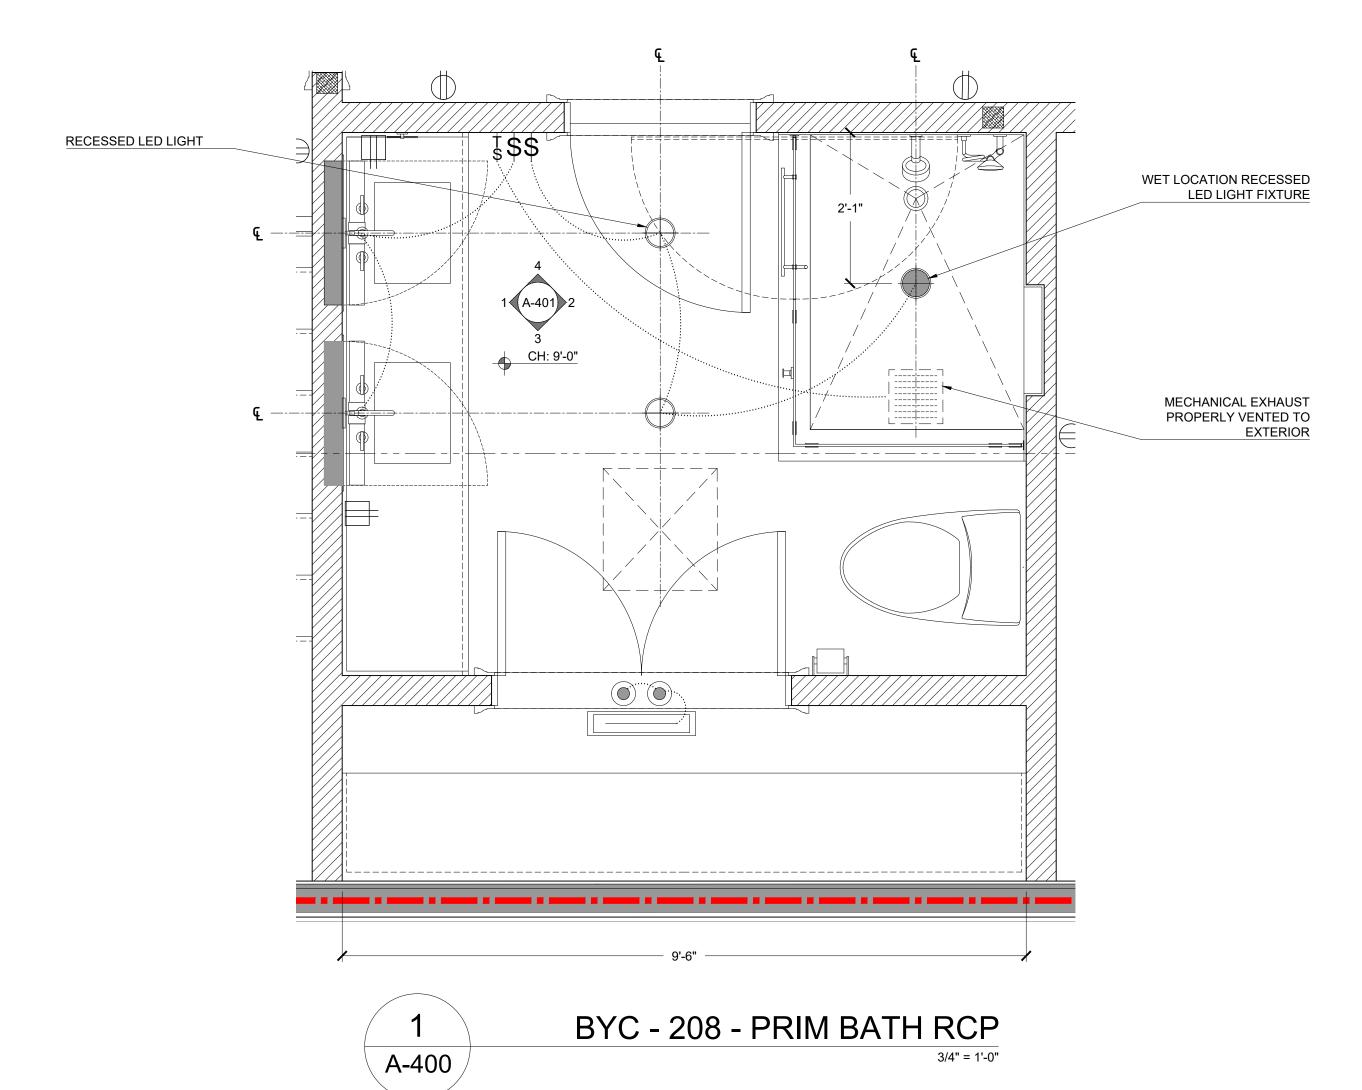



PROPOSED BYC - 208 - PRIM BATH FLOOR PLANS
PROPOSED RESIDENTIAL RENOVATION
ZEPEDA & JONG RESIDENCE
21-23 FRANCESCA AVE.
SOMERVILLE, MA 02144


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PROJECT NUMBER: 202037
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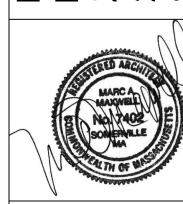
A-400





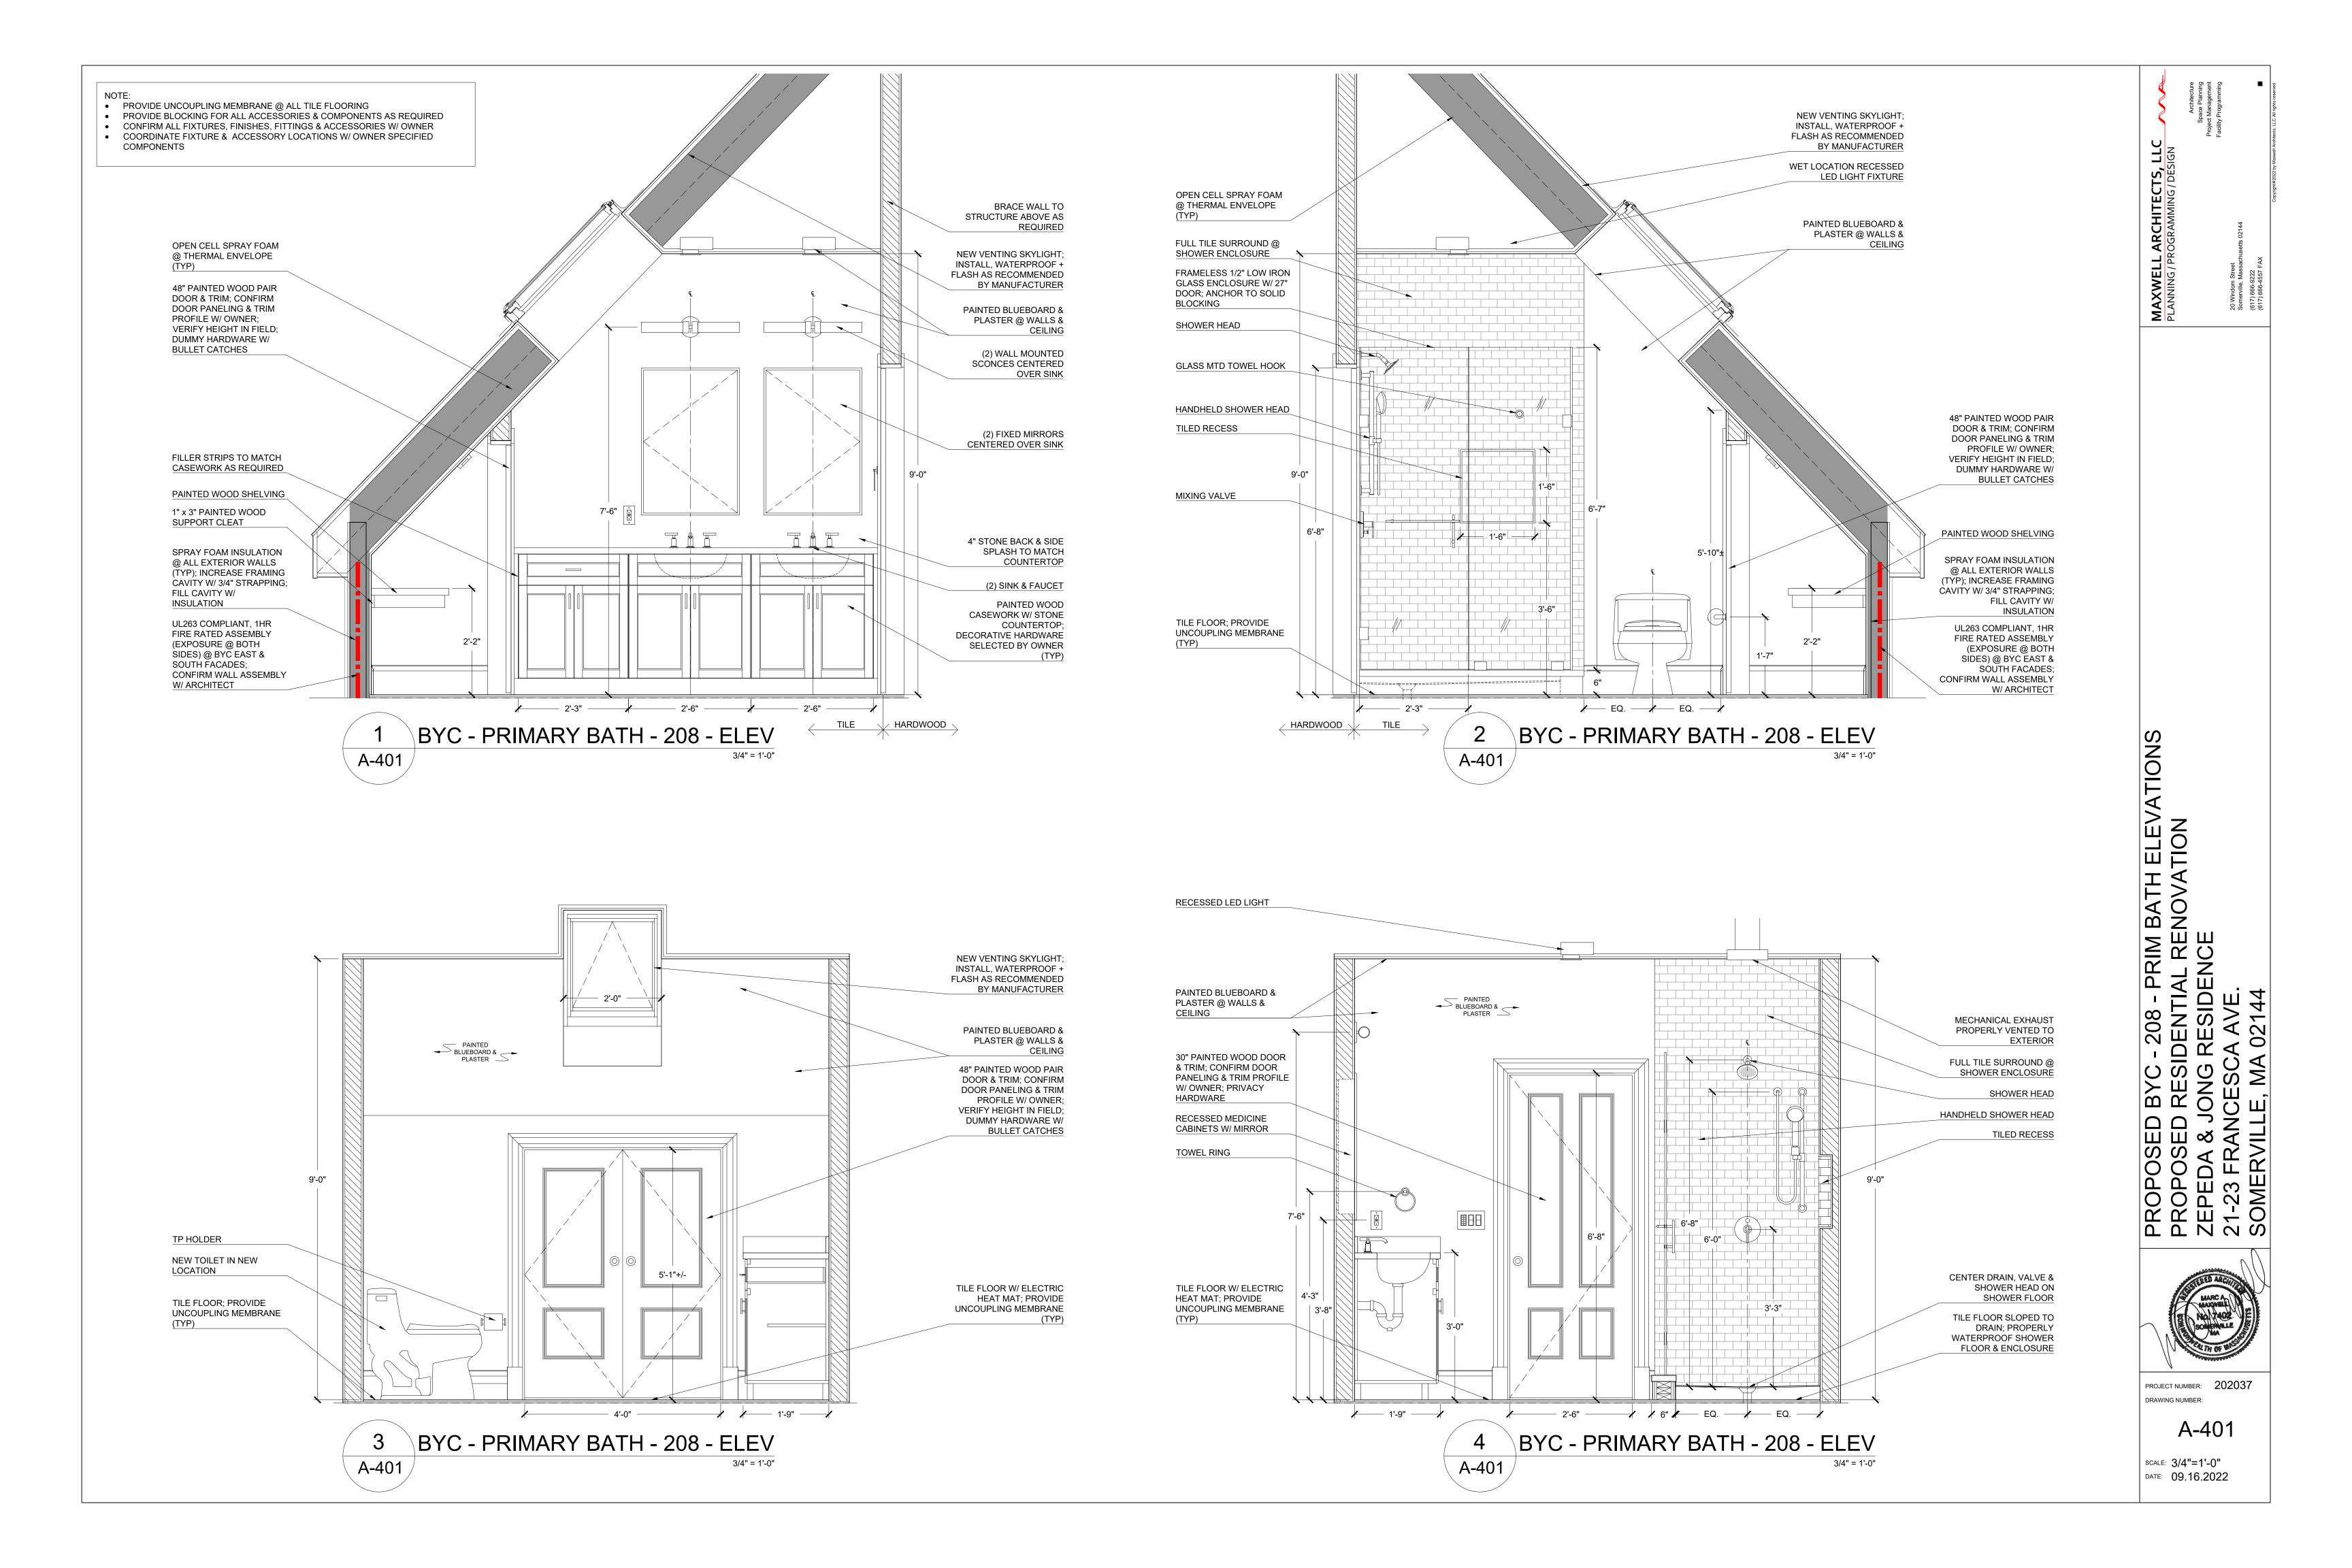


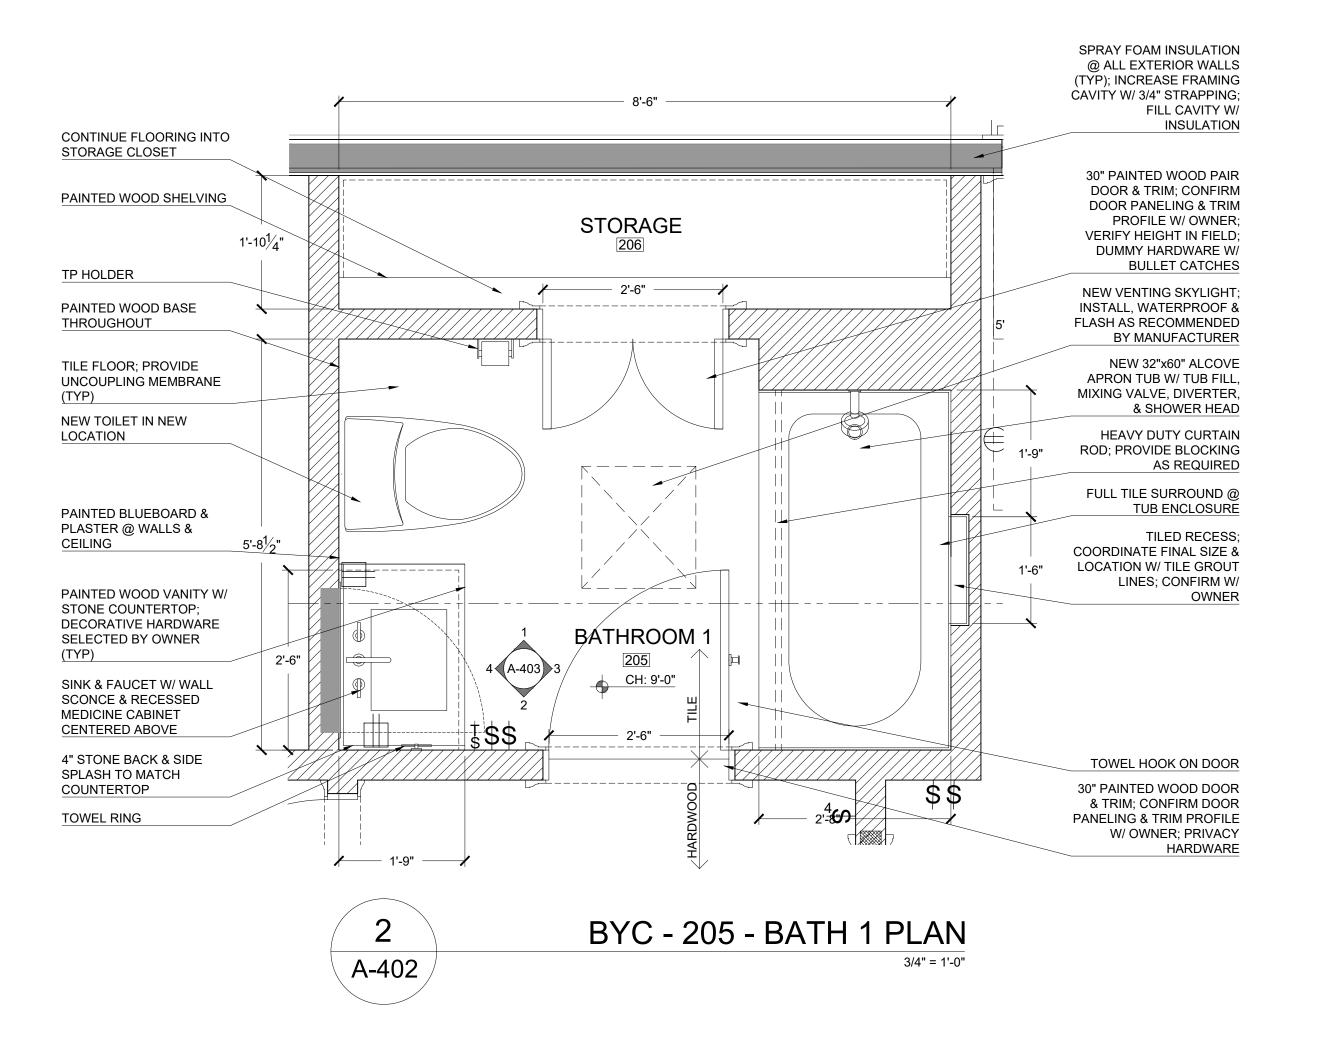PROPOSED BYC - 205 - BATH 1 PLAN FLOOR PLANS
PROPOSED RESIDENTIAL RENOVATION
ZEPEDA & JONG RESIDENCE
21-23 FRANCESCA AVE.
SOMERVILLE, MA 02144

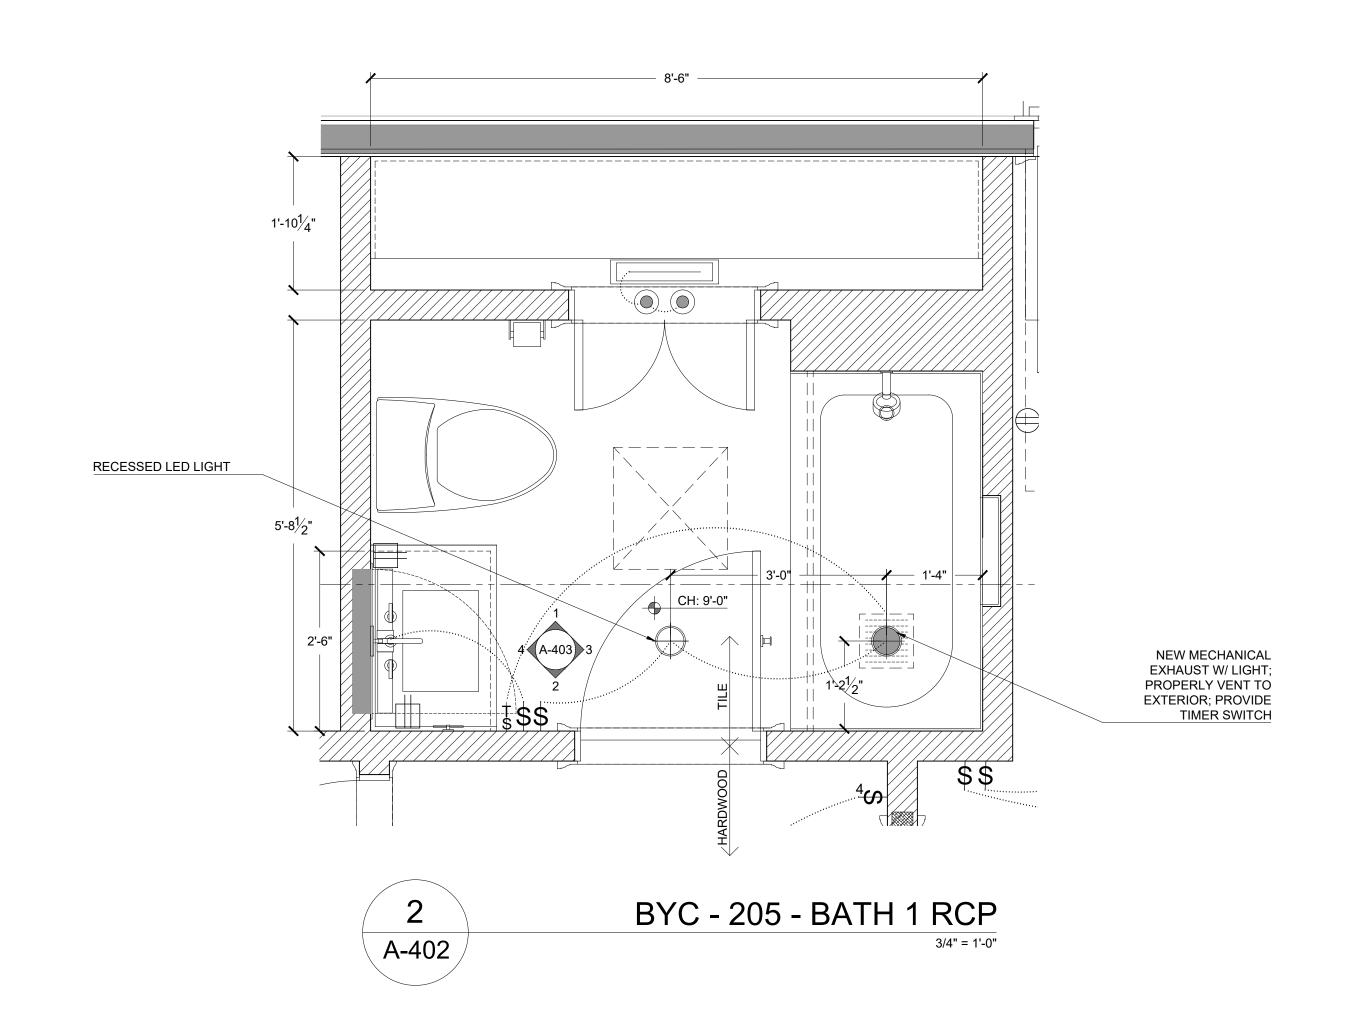

PROJECT NUMBER: 202037
DRAWING NUMBER:

A-402

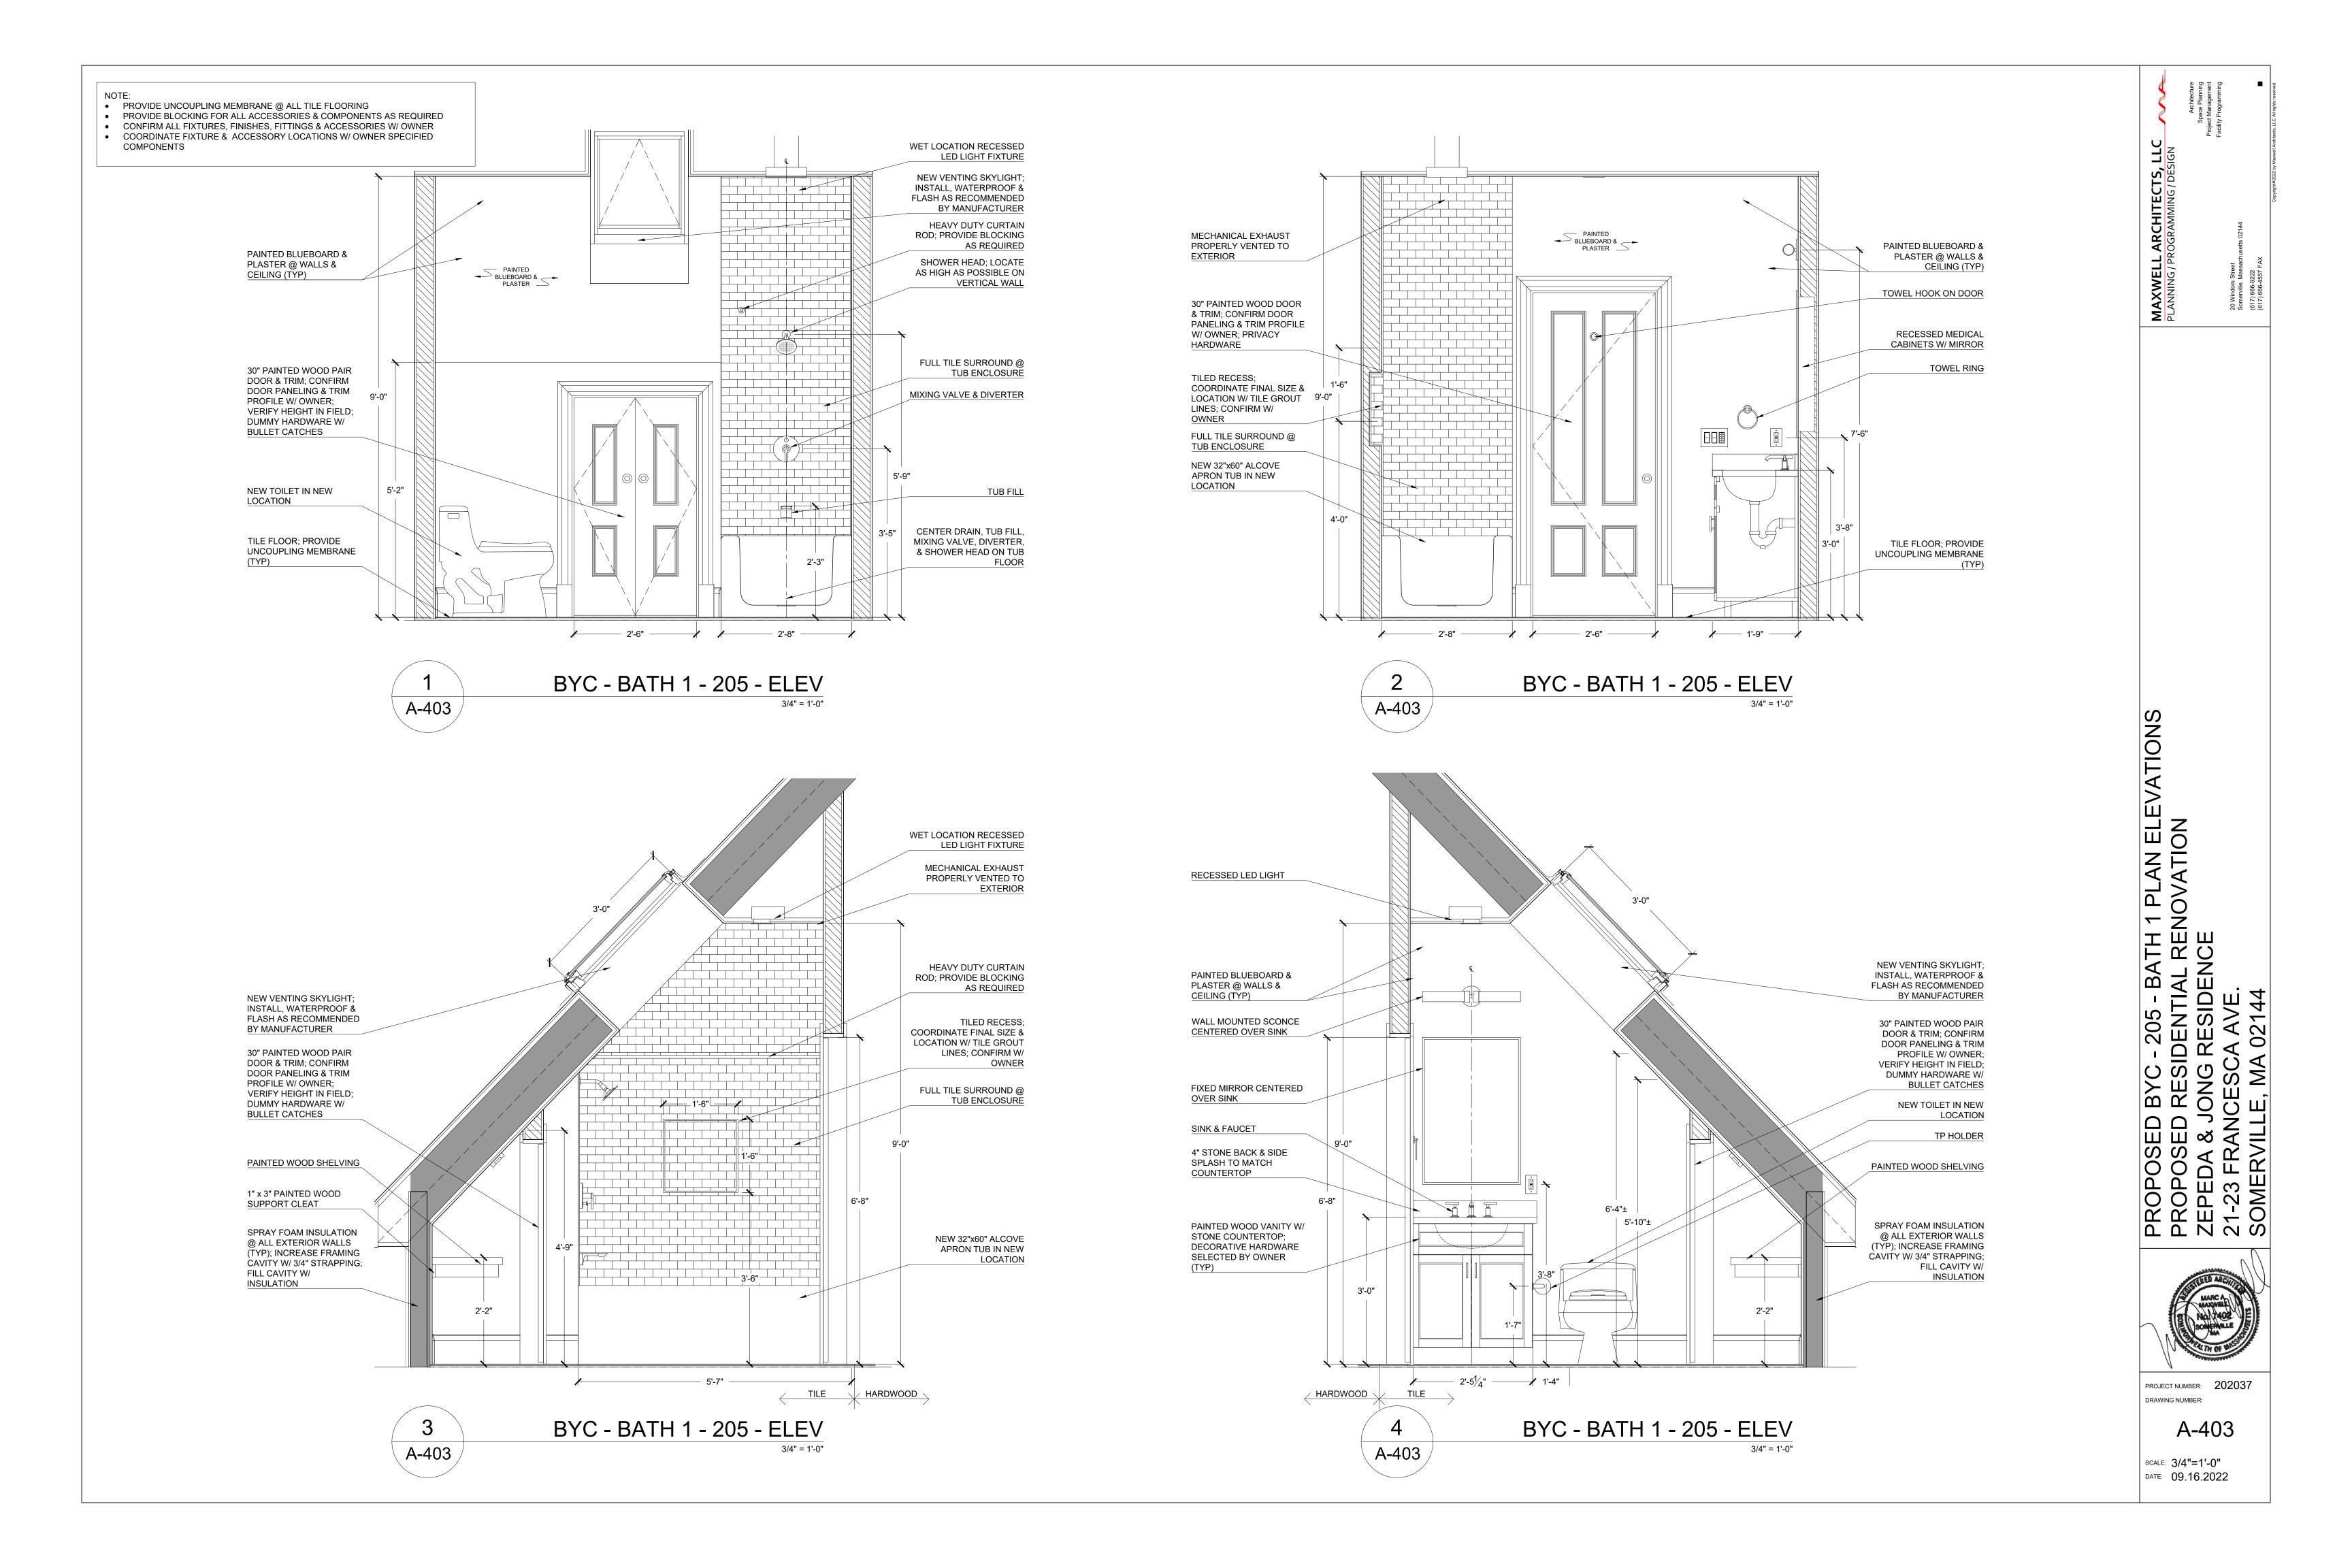


COMPONENTS


 CONFIRM ALL FIXTURES, FINISHES, FITTINGS & ACCESSORIES W/ OWNER COORDINATE FIXTURE & ACCESSORY LOCATIONS W/ OWNER SPECIFIED


106 FLOOR PROPOSED BYC - W/C 1 105 / LAUNDRY 10
PROPOSED RESIDENTIAL RENOVATION
ZEPEDA & JONG RESIDENCE
21-23 FRANCESCA AVE.
SOMERVILLE, MA 02144


PROJECT NUMBER: 202037 DRAWING NUMBER:


A-404

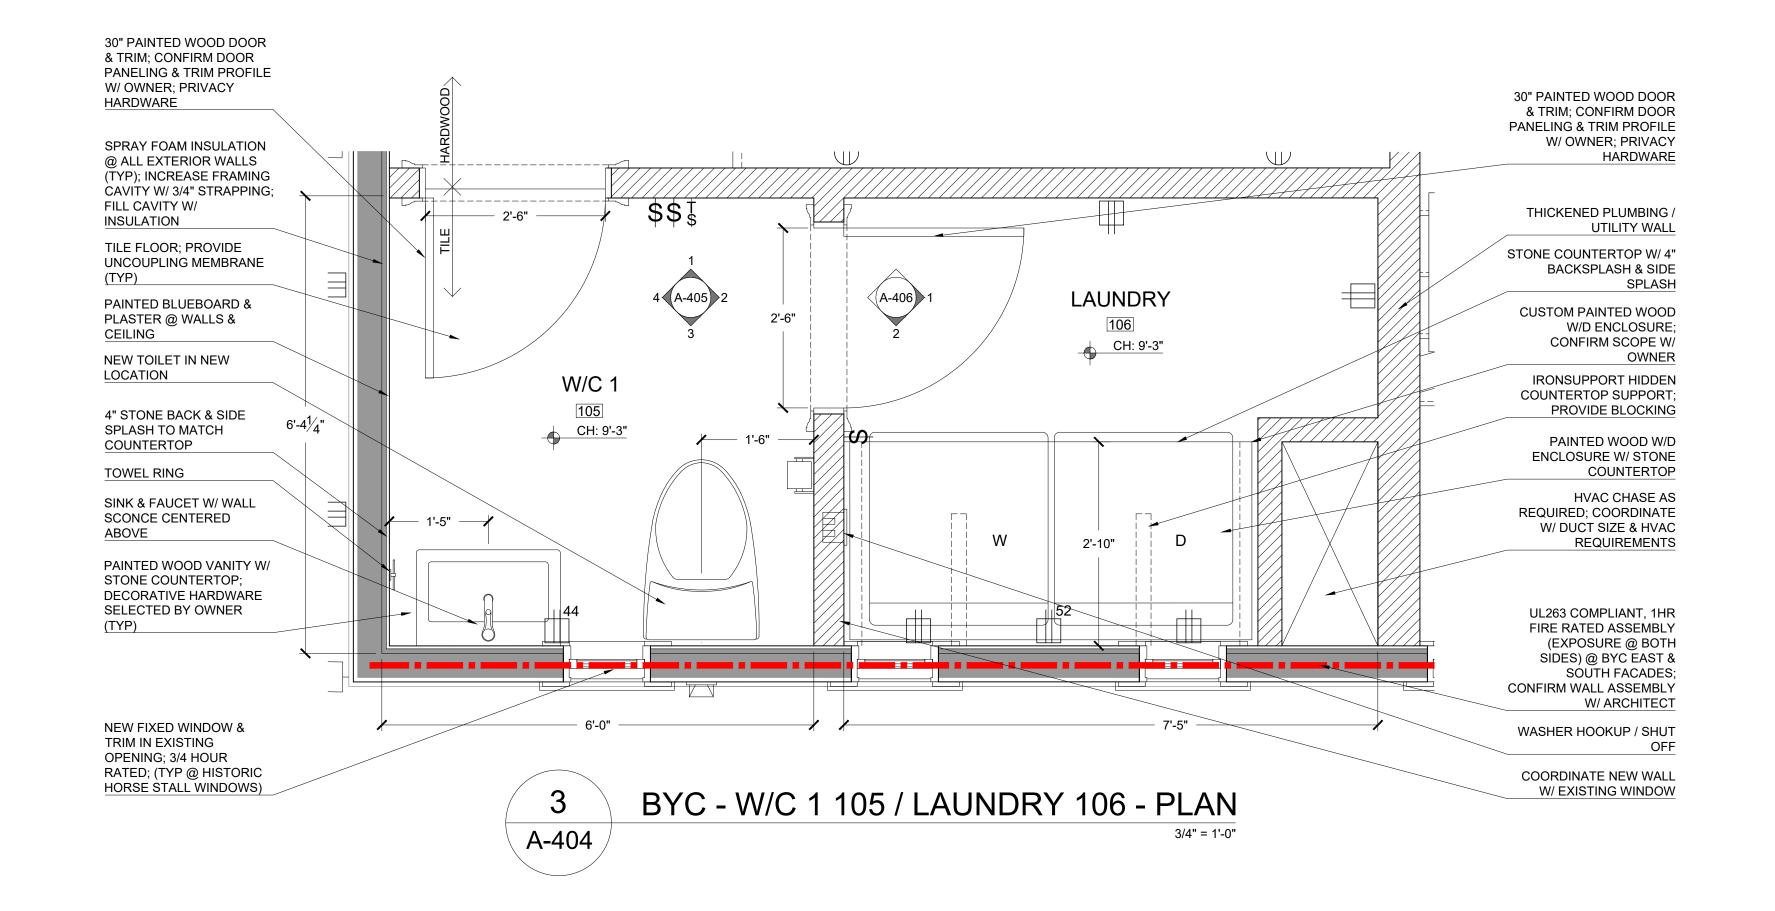

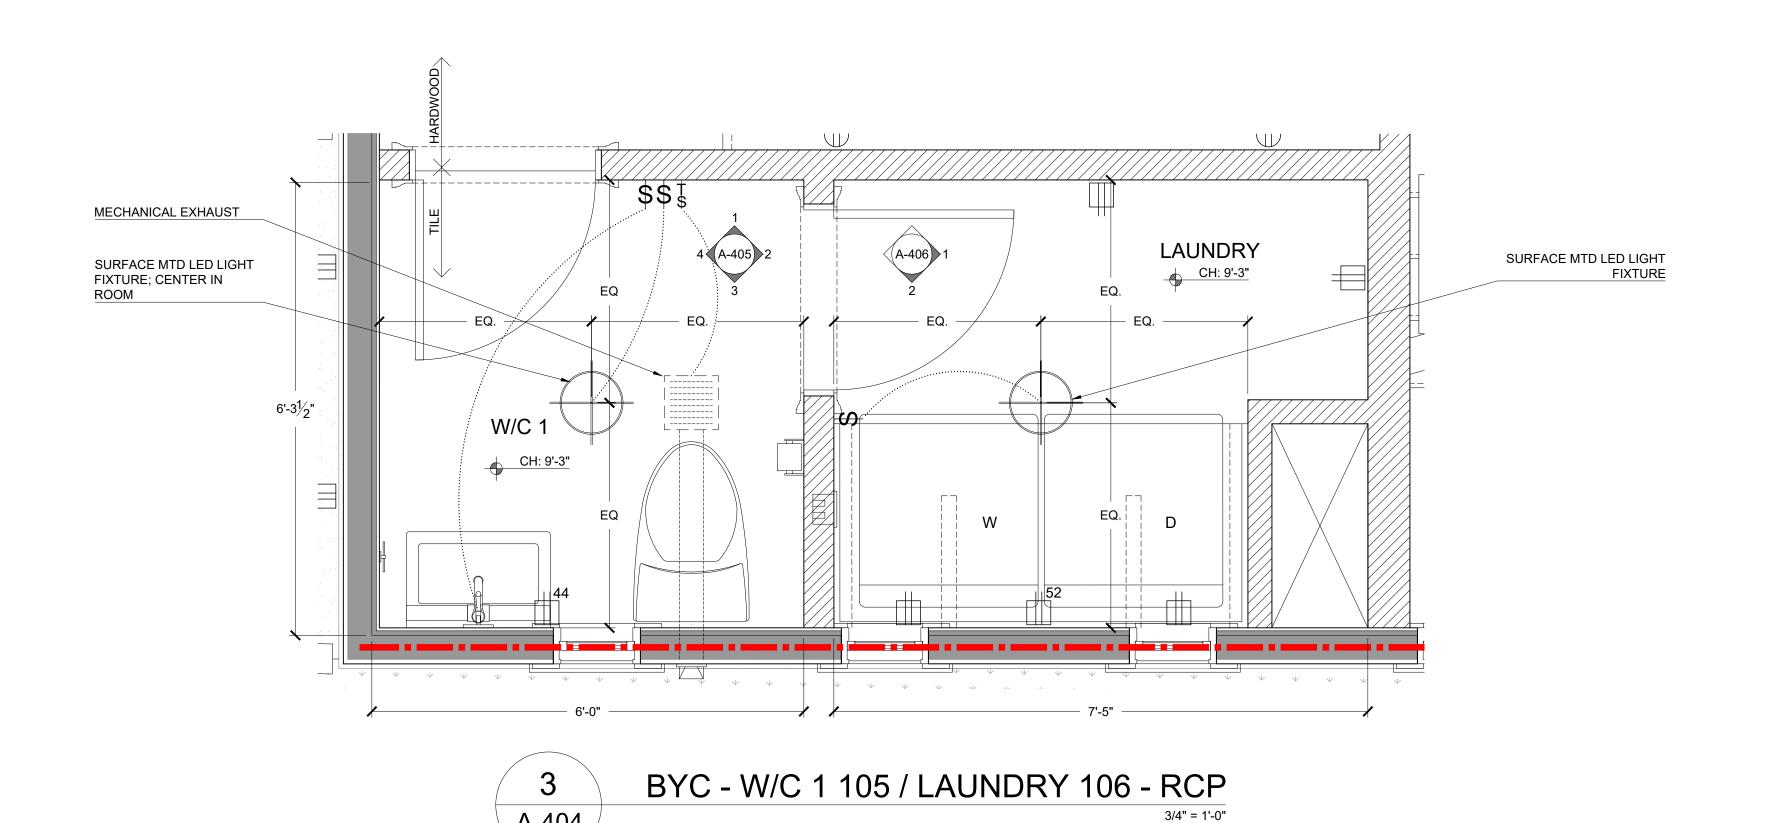

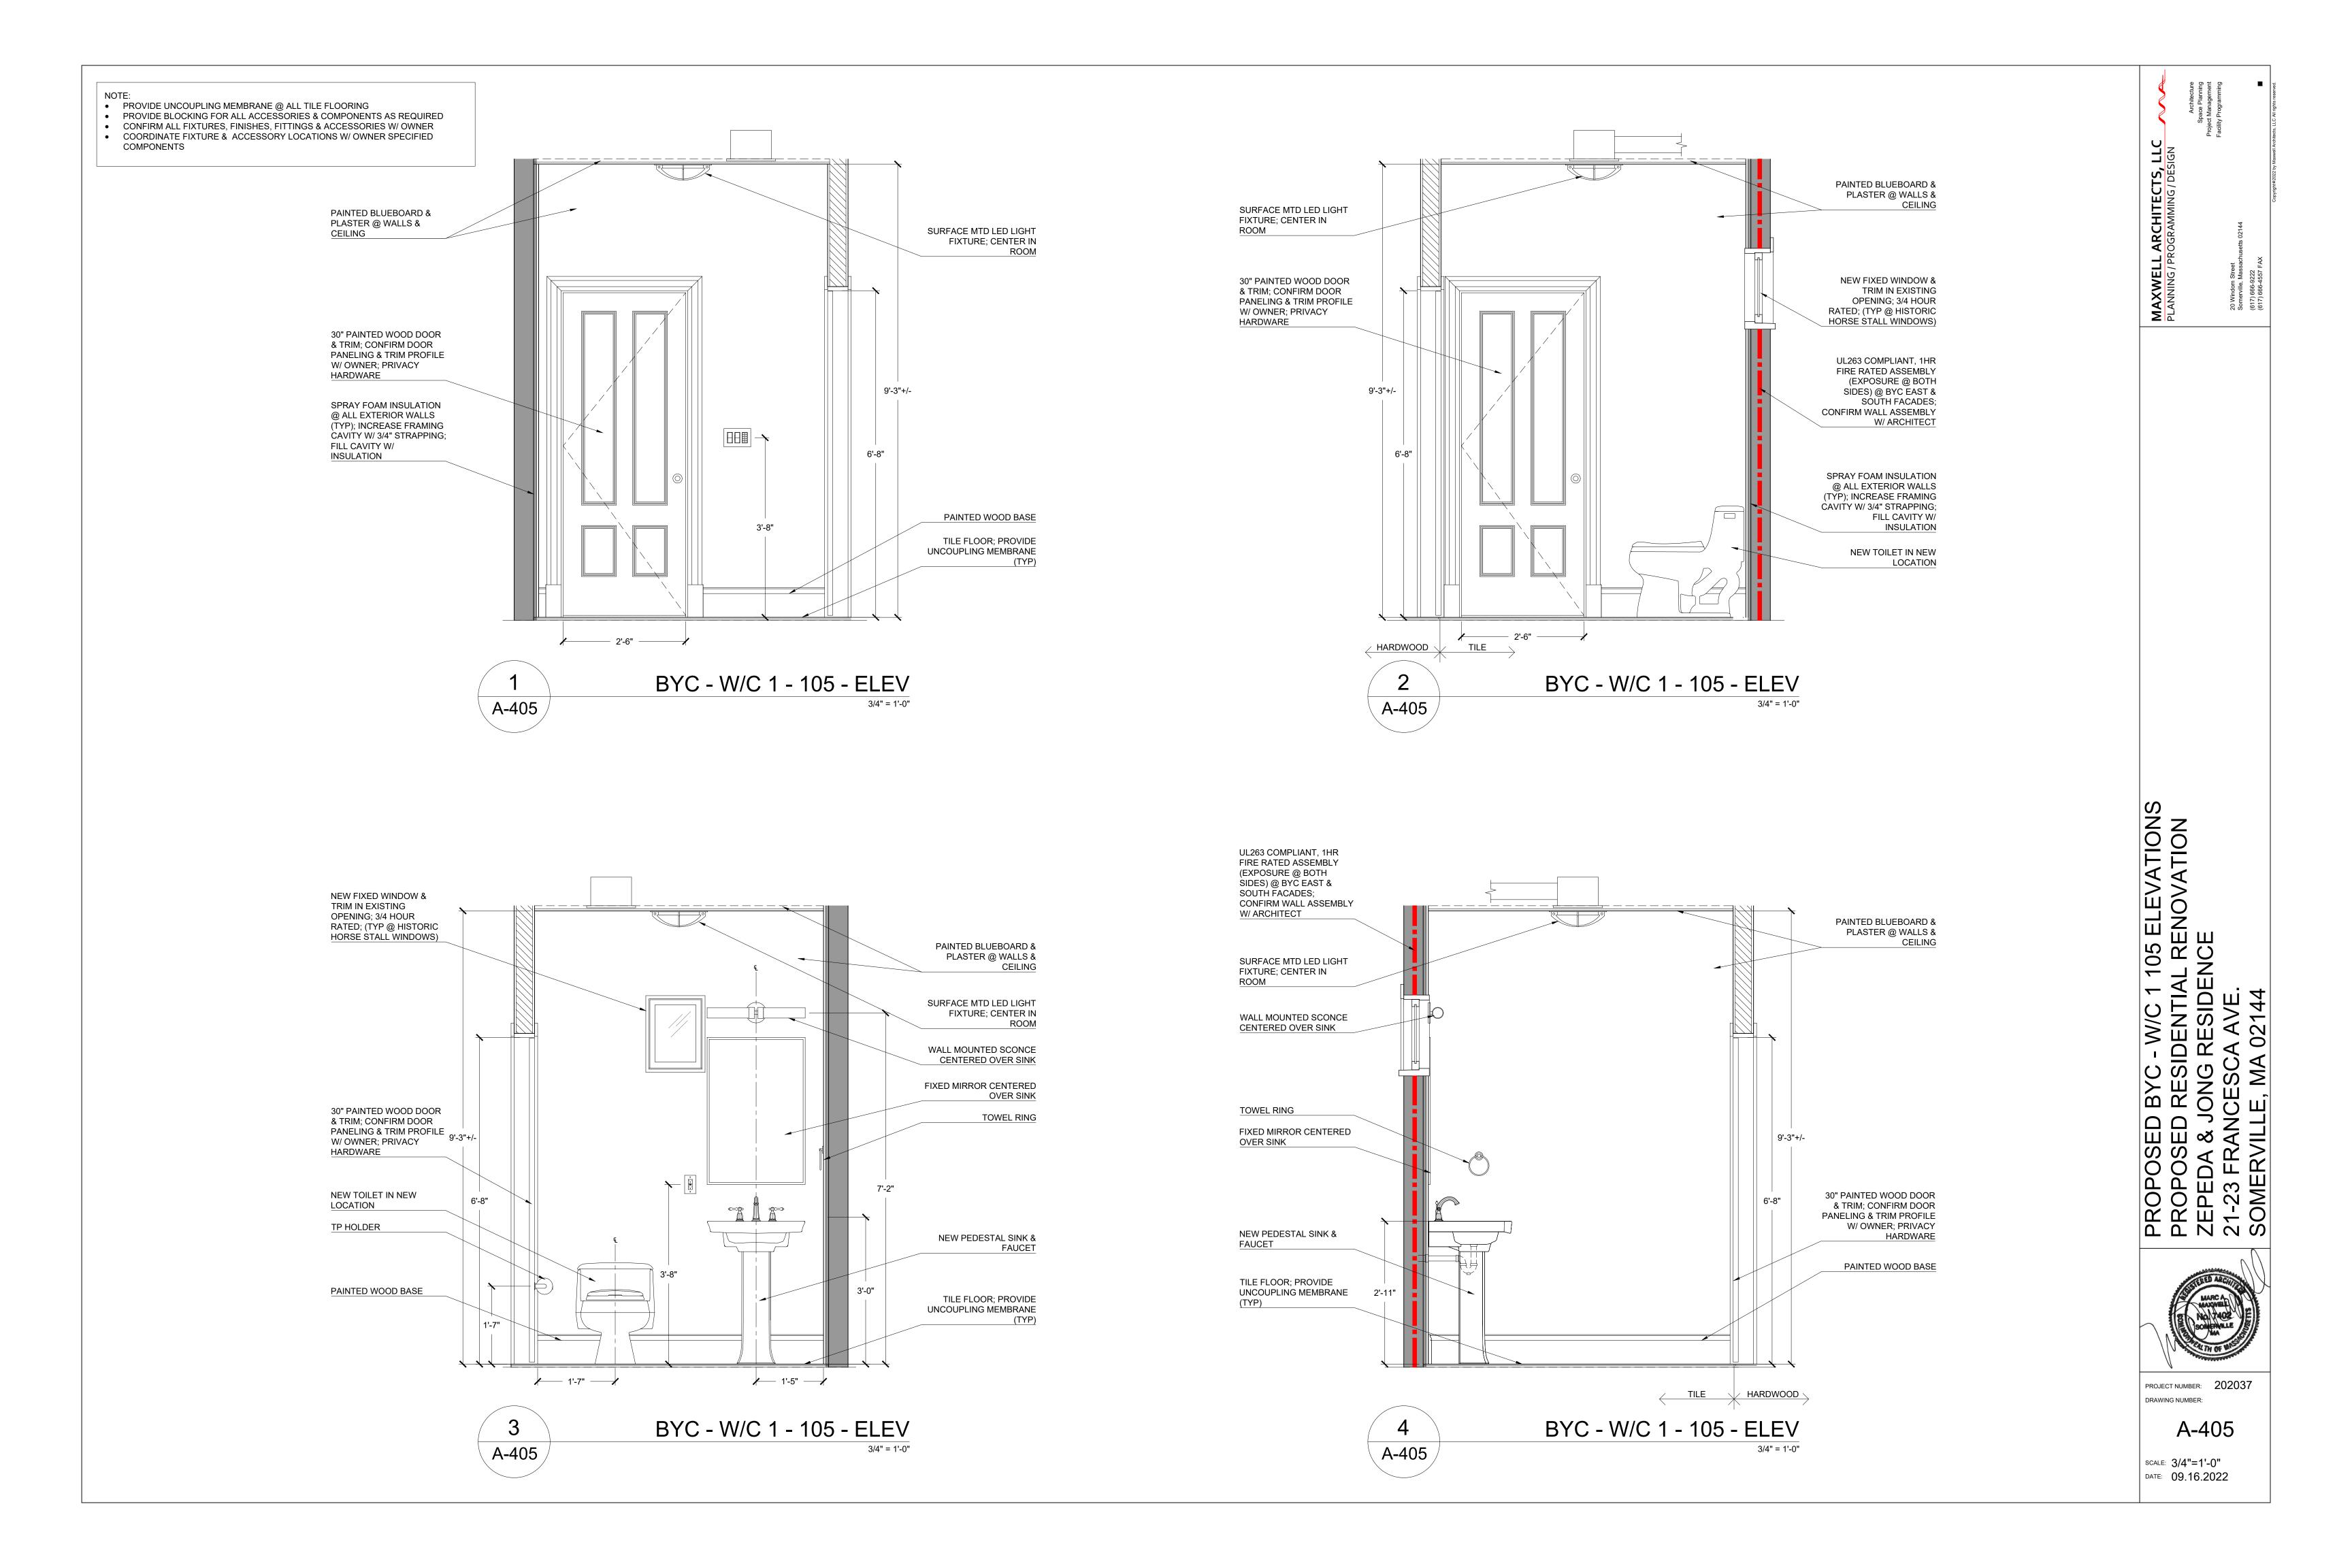

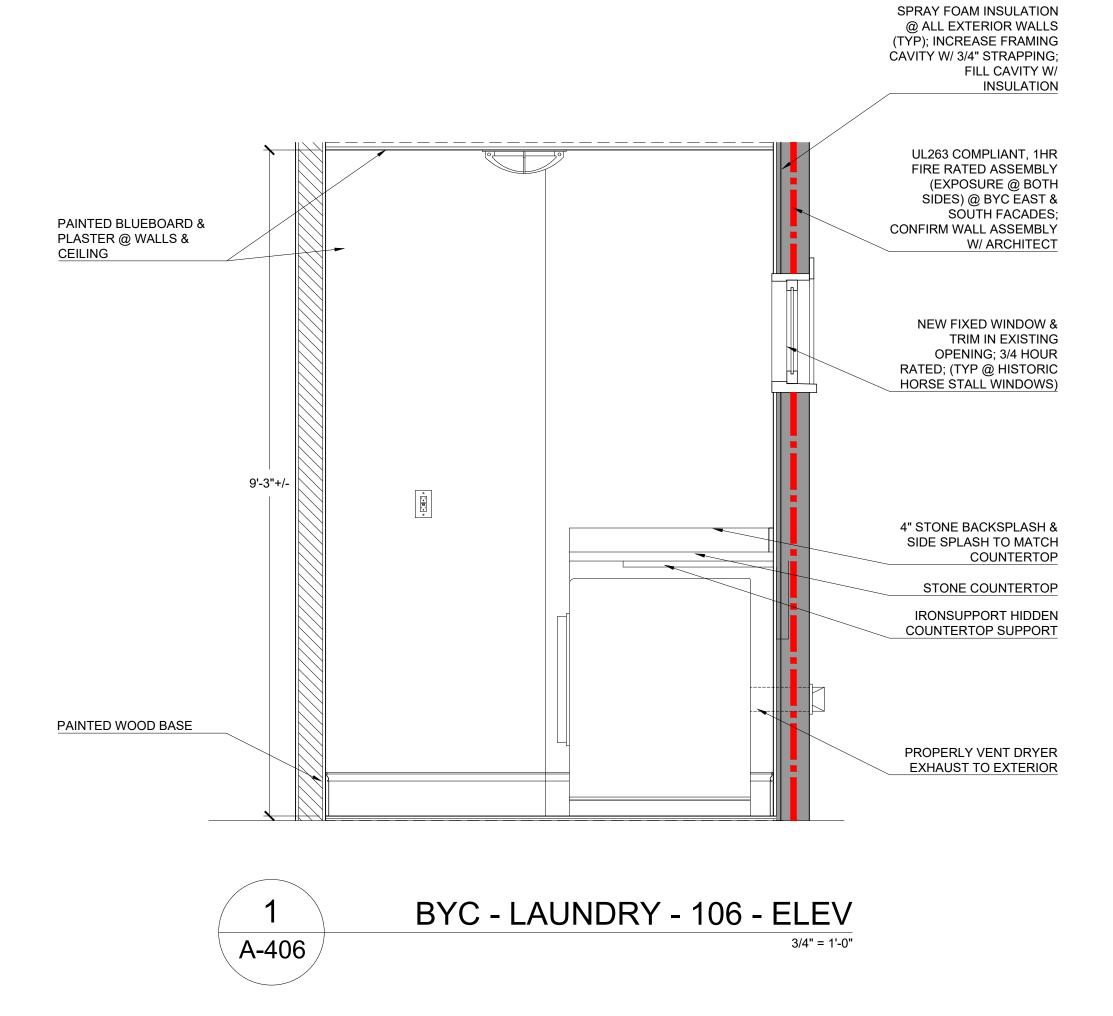

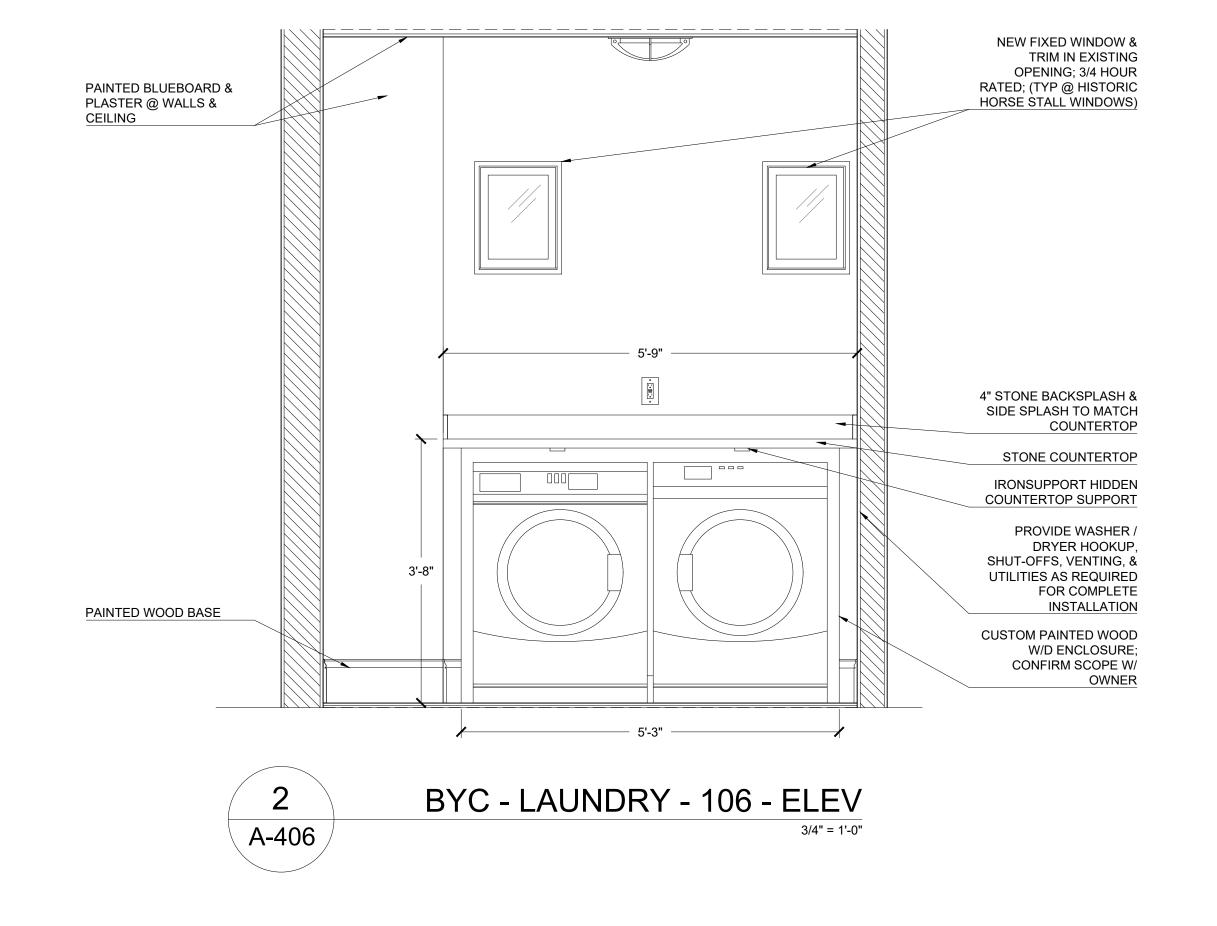



PROPOSED BYC - LAUNDRY 106 ELEVATIONS PROPOSED RESIDENTIAL RENOVATION ZEPEDA & JONG RESIDENCE 21-23 FRANCESCA AVE. SOMERVILLE, MA 02144



PROJECT NUMBER: 202037
DRAWING NUMBER:

A-406

# PROPOSED BACKYARD COTTAGE RENOVATION 21-23 FRANCESCA AVENUE SOMERVILLE, MASSACHUSETTS 02144

OWNER
Manuel Zepeda & Katherine Jong
21 Francesca Avenue
Somerville, MA 02144
617.233.7227

# ARCHITECT Marc A. Maxwell, AIA Principal Architect

John Williams, AIA

Project Architect

20 Windom Street Somerville, MA 02145 617.666.9222

# STRUCTURAL ENGINEER Structures North Consulting Engineers, Inc.

60 Washington Street, Suite 401 Salem, MA 01970 978.745.6817

### **BUILDING CODE ANALYSIS:**

780 CMR 9th Edition - 2015 ICC with MA amendments

Use Group: R-3 (no change)
Construction Type: V

### IEBO

Proposed work is a Level 3 Alteration 801.3 All new construction elements, components, systems, and spaces shall comply with the requirements of the IBC. 908.1 Level 3 alterations to existing buildings or structures are permitted without requiring the entire or structure to comply with the energy requirements of the IECC or IRC. The alterations shall conform to the energy requirements of the IECC or IRC as they relate to new construction only.

### IECC:

R501.1.1 Additions, alterations, or repairs to an existing building, building system or portion thereof shall comply with section R502, R503 or R504. Unaltered portions of the existing building or building supply system shall not be required to comply with this code. Insulation and fenestration requirements by component:

-Climate zone 5
-Fenestration U-factor: .30

-Skylight U-factor: .55
-Ceiling R-value: 49 (See R402.2.2 for ceilings without attic

spaces, R-30 min)
-Wood frame wall R-value: 20 or 13+5ci

-Mass wall R-value: 13/17
-Floor R-value: 30 (Or fill framing cavity, R-19 min)
-Basement wall R-value: 15/19

-Basement wall R-value: 15/19 -Slab R-value & depth: 10, 4'

-Crawl space wall R-value: 15/19

R310.1 Basements, habitable attics, and every sleeping room shall have not less than one operable emergency escape and rescue opening.
R311.1 Dwellings shall be provided with a means of egress in

accordance with section R311.
R313.2 Only one and two-family dwellings having an aggregate area greater than 14,400 SF shall have fire sprinklers installed in

accordance with NFPA 13D
R313.2.1 Automatic residential fire sprinkler systems shall be designed and installed in accordance with Section NFPA 13D


### PROJECT NARRATIVE:

This project consists of a full gut renovation of the existing rear yard structure on the property. All existing MEP-FA systems will be replaced with new high efficiency systems to meet current building codes and standards. Insulation and energy conservation components will also be upgraded to meet current building codes and standards. The existing structure requires extensive structural modification and reinforcement to accommodate the conversion and preserve the existing building; including a full foundation replacement. Expansive existing asphalt will be removed and replaced with green score compliant landscaping and permeable surfaces.

### **ZONING ANALYSIS**

### Zone: NR

Existing Carriage House/Barn			
3.1.12 Backyard Cottage			
	Required	Provided	
Lot Dimensions			
Lot Width (front driveway access)	34 ft	50 ft (existing)	conforming
Lot Depth	80 ft	101.52 ft (existing)	conforming
Lot Development			
Lot Coverage (maximum)	60%	49%	conforming
Green Score	0.35 minimum	0.38	conforming
Building Setbacks			
Primary Front Setback (min/max)	60 ft (min)	74'-9" (existing)	conforming
Side Setbacks	3 ft	1'-10" east	existing non-conforming
	3 ft	5'-7" west	conforming
Rear Setback (min) Main House	3 ft	1'-8"	existing non-conforming
Building Separation (min)			
Main house to Carriage House	10 ft	15'-6"	conforming
Carriage House to 17-19 Garage	10 ft	7'-1"	existing non-conforming
Main Massing			
Width (max)	24 ft	42'-5"	existing non-conforming
Depth (max)	32 ft	24'-5"	conforming
Floor Plate (max)	576 sf	975 sf (existing)	existing non-conforming
Story Height (max)	12 ft	10'-9" (existing)	conforming
Number of Stories (max)	1.5	1.5	conforming
Roof Type	Flat, Gable	Gable/Hip with Cupola	conforming
Façade Composition			
Ground Story Fenestration Residential Use (min/max)	15%- 50%	19%	conforming
Ground Story Fenestration Vehicular Parking (min/max)	0%- 50%	0%	conforming
Upper Story Fenestration (min/max)	15%-50%	NA	
Use & Occupancy			
Dwelling Units per Lot (max)	3	2	conforming
Dwelling Units (max)	1	1	conforming

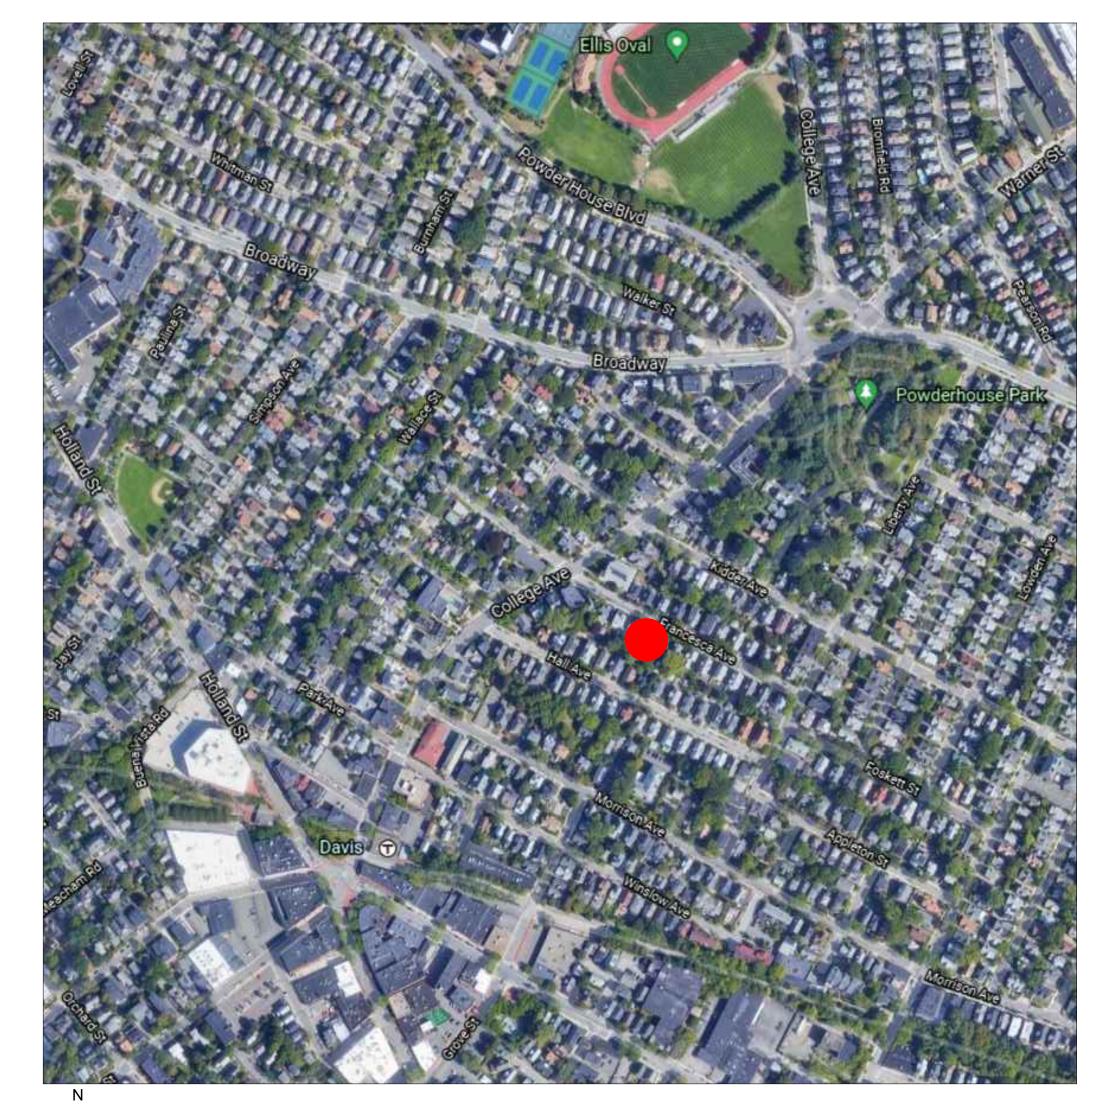

LOCUS MAP



PROPOSED MASSING MODEL

CUS, & MASSING TION

PROPOSED ZONING ANALYSIS, LOUR PROPOSED RESIDENTIAL RENOV ZEPEDA & JONG RESIDENCE 21-23 FRANCESCA AVE. SOMERVILLE, MA 02144



PROJECT NUMBER: 202037
DRAWING NUMBER:

T-100

SCALE: AS NOTED DATE: 12.23.2022

DRAWING LIST				
SHEET	TITLE	DATE		
	ARCHITECTURAL			
T-100	PROPOSED ZONING ANALYSIS, ZONING & MASSING	12.23.2022		
T-101	TITLE SHEET, LEGENDS & GENERAL NOTES	12.23.2022		
EX-100	EXISTING PLANS			
EX-101	EXISTING PLANS			
EX-200	EXISTING PRIMARY STRUCTURE ELEVATIONS	12.23.2022		
EX-201	EXISTING PRIMARY STRUCTURE ELEVATIONS	12.23.2022		
EX-202	EXISTING BACKYARD COTTAGE ELEVATIONS	12.23.2022		
EX-203	EXISTING BACKYARD COTTAGE ELEVATIONS	12.23.2022		
AD-111	BASEMENT & FIRST FLOOR DEMO PLANS	12.23.2022		
AD-112	SECOND FLOOR DEMO PLANS	12.23.2022		
A-100	PROPOSED SITE PLAN & ROOF PLAN	12.23.2022		
A-111	BYC BASEMENT & FIRST FLOOR PLANS	12.23.2022		
A-112	BYC SECOND FLOOR PLAN	12.23.2022		
A-113	BYC BASEMENT & FIRST FLOOR RC PLANS	12.23.2022		
A-114	BYC SECOND FLOOR RC PLAN	12.23.2022		
A-202	BYC PROPOSED NORTH & WEST ELEVATION	12.23.2022		
A-203	BYC PROPOSED SOUTH & EAST ELEVATION	12.23.2022		
A-400	BYC PROPOSED - 208 - PRIM BATH FLOOR PLANS	12.23.2022		
A-401	BYC PROPOSED - 208 - PRIM BATH FLOOR ELEVATIONS	12.23.2022		
A-402	BYC PROPOSED - 205 - BATH 1 FLOOR PLANS	12.23.2022		
A-403	BYC PROPOSED - 205 - BATH 1 ELEVATIONS	12.23.2022		
A-404	BYC PROPOSED - W/C 1 105 / LAUNDRY 106 F. PLANS	12.23.2022		
A-405	BYC PROPOSED - W/C 1 105 ELEVATIONS	12.23.2022		
A-406	BYC PROPOSED - LAUNDRY 106 ELEVATIONS	12.23.2022		
	STRUCTURAL (BYC)			
S-001	BYC NOTES	09.15.2022		
S-101	BYC FRAMING PLANS	09.15.2022		
S-201	BYC DETAILS	09.15.2022		
S-202	BYC DETAILS	09.15.2022		
		0011012022		

	LEGEND				
	NEW GWB PARTITION				
<u> </u>	NEW GWB PARTITION W/ 2x6 FRAMING OR AS REQUIRED FOR PLUMBING				
	PARTITION/COMPONENT TO BE DEMOLISHED				
\$	ELECTRICAL SWITCH				
<b>\$</b> <sup>3</sup>	3-WAY ELECTRICAL SWITCH				
† \$	TIMER SWITCH				
$\sqrt{}$	DATA JACK				
Ф	DUPLEX OUTLET				
#	QUADPLEX OUTLET				
Ш	GFCI OUTLET				
•	COAXIAL CABLE JACK				
T	THERMOSTAT				
The same of the sa	ELECTRICAL CIRCUIT				
$\oplus$	RECESSED CEILING LIGHT FIXTURE				
<b>\Phi</b>	RECESSED CEILING WET LOCATION LIGHT FIXTURE				
	CEILING MOUNTED PENDANT LIGHT FIXTURE				
	SURFACE MOUNTED WALL SCONCE				
$\bigoplus$	SURFACE MOUNTED CEILING LIGHT FIXTURE				
<u></u>	SIDE MOUNTED LINEAR LIGHT FIXTURE				
	SURFACE MOUNTED CLOSET LIGHT FIXTURE				
<u>«</u>	UNDER CABINET/SHELF LINEAR LIGHT FIXTURE				
	CEILING MOUNTED EXHAUST FAN				
⊕ SD	SMOKE DETECTOR				
⊕ <sub>co</sub>	CO DETECTOR				

## REFLECTED CEILING PLAN NOTES

- NEW MEP-FA SYSTEMS; SEE MEP-FA DRAWINGS. SUBMIT COORDINATED SHOP DRAWINGS FOR APPROVAL.
- DIMENSIONS & WORK NOTED ON THESE DRAWINGS ARE NOTED FOR DESIGN INTENT. NOTIFY ARCHITECT PRIOR TO INSTALLATION IF THE INSTALLATION OF ELECTRICAL, MECHANICAL, PLUMBING, OR FIRE PROTECTION WORK INTERFERES WITH THIS INTENT.
- REFER TO ELECTRICAL DRAWINGS FOR ALL CIRCUITING & SWITCHING INFORMATION. NOTIFY ARCHITECT OF DISCREPANCIES PRIOR TO INSTALLATION.
- GROUPINGS OF SPRINKLER HEADS, LIGHT FIXTURES, DIFFUSERS, ETC. TO BE CENTERED WITHIN ROOMS, UNO.
- COORDINATE LINEAR RUNS OF SPRINKLER HEADS, LIGHT FIXTURES, DIFFUSERS, ETC, TO BE ALIGNED ON CENTER, UNO.
- DIMENSIONS ARE TO CENTER OF FIXTURE, UNO.
- HVAC DIFFUSERS, EQUIPMENT ACCESS PANELS, SPRINKLER HEAD ESCUTCHEON PLATES, SMOKE DETECTORS, SECURITY FEATURES, AUDIO DEVICES, ETC. TO MATCH ADJACENT CEILING FINISH, UNO.
- DEMO OBSOLETE EQUIPMENT. CABLING. WIRING. & DEVICES.
- PROVIDE 7'-6" MIN. CEILING HEIGHT. RELOCATE EXISTING OBSTRUCTIONS AS REQUIRED.
- CEILING HEIGHTS NOTED ARE FROM TOP OF FINISHED FLOOR TO UNDERSIDE OF FINISHED CEILING, UNO.
- ALL ELECTRICAL CONDUIT, WIRING, PLUMBING LINES, & OTHER SERVICES TO BE ROUTED THROUGH CLOSED CEILINGS. FRAMED WALLS, ETC. AS NECESSARY TO CONCEAL FROM VIEW, UNO.
- CONFIRM CEILING HEIGHTS NOTED PROVIDE ADEQUATE CLEARANCE FOR ALL EXISTING & NEW MEP-FA EQUIPMENT & COMPONENTS.
- PROVIDE ACCESS PANELS TO ALL ABOVE CEILING & IN WALL CONTROLS, TRANSFORMERS, SHUT OFFS, ETC.. COORDINATE EXACT LOCATIONS, SIZES, & QUANTITIES W/ ARCHITECT/OWNER.

### **GENERAL NOTES**

- COMPLY WITH APPLICABLE CODES, REGULATIONS, ORDINANCES AND REQUIREMENTS OF AUTHORITIES HAVING JURISDICTION, INCLUDING ACCESSIBILITY GUIDELINES WHERE APPLICABLE. SUBMIT COPIES OF INSPECTION REPORTS, NOTICES AND SIMILAR DOCUMENTS TO ARCHITECT. PLANS ARE BASED ON MASSACHUSETTS BUILDING CODE 9TH EDITION.
- THE CONTRACTOR, SUBCONTRACTORS, AND MATERIAL SUPPLIERS SHALL REFER TO THE DRAWINGS, SCHEDULES AND SPECIFICATIONS AS A WHOLE WHEN DETERMINING THE CONSTRUCTION REQUIREMENTS FOR THE PROJECT.
- THE CONTRACTOR IS RESPONSIBLE FOR IDENTIFYING ALL AREAS ON THE PROJECT WHICH REQUIRE TOLERANCES BETWEEN ROUGH OPENINGS AND/OR FINISH MATERIALS AND PROVIDE FOR THE PROPER TOLERANCES TO COMPLETE THE CONSTRUCTION IN ACCORDANCE WITH THE REQUIREMENTS OF THE CONTRACT DOCUMENTS.
- ALL DRAWINGS, SCHEDULES AND SPECIFICATIONS IN THE BID PACKAGE ARE TO BE CONSIDERED EQUAL PARTS OF THIS CONTRACT PACKAGE. THE CONTRACTOR AND SUBCONTRACTORS SHALL BE RESPONSIBLE FOR THE REVIEW AND COORDINATION OF ALL DRAWINGS, SCHEDULES AND SPECIFICATIONS. ALL DISCREPANCIES OMISSIONS OR ERRORS THAT OCCUR SHALL BE BROUGHT TO THE ATTENTION OF THE ARCHITECT IN WRITING PRIOR TO THE SUBMISSION OF BIDS SO THAT CLARIFICATION MAY BE ISSUED.
- DRAWINGS AND SPECIFICATIONS ARE INTENDED TO PROVIDE THE BASIS FOR THE PROPER COMPLETION OF THE PROJECT SUITABLE FOR THE INTENDED USE OF THE OWNER. ITEMS NOT EXPRESSLY SET FORTH BUT WHICH ARE REASONABLY IMPLIED OR NECESSARY FOR THE PROPER PERFORMANCE OF THIS WORK SHALL BE INCLUDED.
- ANY WORK PERFORMED IN CONFLICT WITH ANY PART OF THE CONTRACT DOCUMENTS OR ANY CODE REQUIREMENT SHALL BE
- CORRECTED BY THE CONTRACTOR AT THEIR OWN EXPENSE AND AT NO EXPENSE TO THE OWNER OR ARCHITECT • THE CONTRACTOR SHALL NOTIFY THE ARCHITECT WHEN, IN THE COURSE OF CONSTRUCTION OR DEMOLITION, CONDITIONS ARE UNCOVERED WHICH ARE UNANTICIPATED OR OTHERWISE APPEAR TO PRESENT A DANGEROUS CONDITION.
- THE CONTRACTOR AND SUBCONTRACTORS SHALL BE RESPONSIBLE FOR COORDINATION OF THEIR WORK WITH THE WORK OF OTHER TRADES. SUBCONTRACTORS SHALL VERIFY THAT ANY WORK RELATED TO THEM, WHICH MUST BE PROVIDED BY OTHERS HAS BEEN COMPLETED AND IS ADEQUATE PRIOR TO COMMENCING THEIR WORK.
- ALL DIMENSIONS SHALL TAKE PRECEDENCE OVER SCALE SHOWN ON PLANS, SECTIONS AND DETAILS. DIMENSIONS ARE TO FACE OF FINISH UNLESS OTHERWISE NOTED ON DRAWINGS. DO NOT SCALE DRAWINGS. NOTIFY THE ARCHITECT/ENGINEER OF ANY DISCREPANCIES AND DO NOT PROCEED WITHOUT INSTRUCTIONS/CLARIFICATION.
- THE CONTRACTOR SHALL VERIFY ALL CONDITIONS AND DIMENSIONS AND REPORT ANY DISCREPANCIES TO THE ARCHITECT/ENGINEER.
- VERIFY ALL SITE CONDITIONS PRIOR TO COMMENCING CONSTRUCTION.
- THE CONTRACTOR SHALL BE SOLELY RESPONSIBLE FOR JOB SITE SAFETY OF ITS EMPLOYEES AND OTHER PERSONS IN THE CONSTRUCTION AREA, AS WELL AS FOR THE PROTECTION OF THE SAFETY OF THE IMPROVEMENTS BEING ERECTED AND THE PROPERTY OF THE CONTRACTOR AND/OR OTHER PERSONS, AS A RESULT OF OPERATIONS HEREUNDER.
- CONTRACTOR IS RESPONSIBLE FOR ALL SHORING & SHORING ENGINEERING AS REQUIRED BY THE PROJECT.
- THE CONTRACTOR SHALL BE FULLY AND COMPLETELY LIABLE AT HIS OWN EXPENSE FOR DESIGN, CONSTRUCTION, INSTALLATION AND USE OR NON-USE OF ALL ITEMS AND METHODS INCIDENT TO PERFORMANCE OF EITHER PERSON OR PROPERTY, INCLUDING WITHOUT LIMITATION THE ADEQUACY OF ALL TEMPORARY SUPPORTS, SHORING, BRACING, SCAFFOLDING, MACHINERY OR EQUIPMENT, SAFETY PRECAUTIONS OR DEVICES, AND SIMILAR ITEMS OR DEVICES USED DURING CONSTRUCTION.
- THE CONTRACTOR SHALL FURNISH ALL MATERIALS, LABOR, AND EQUIPMENT NECESSARY TO PROPERLY COMPLETE THE WORK, INCLUDING ITEMS NOT SPECIFICALLY SET FORTH IN THE CONSTRUCTION DOCUMENTS.
- THE CONTRACTOR SHALL COORDINATE ALL WORK WITH THE OWNER OR WITH THE OWNER'S REPRESENTATIVE.
- THE CONTRACTOR SHALL OBTAIN AND BE RESPONSIBLE FOR ALL FEES, PERMITS, AND INSPECTIONS REQUIRED AND ASSOCIATED WITH ALL PHASES OF THE WORK.
- ALL ITEMS TO BE REMOVED SHALL BECOME PROPERTY OF THE CONTRACTOR AND SHALL BE REMOVED ENTIRELY FROM THE PROJECT SITE, UNLESS NOTED OTHERWISE. RETURN ITEMS IDENTIFIED FOR SALVAGE OR REUSE TO THE OWNER/PROPERTY
- THE DRAWINGS ARE NOT INTENDED FOR USE AS SHOP OR ERECTION DRAWINGS. PROVIDE SHOP DRAWINGS WHEN
- CONTRACTOR TO PHASE ALL WORK SUCH THAT THE OCCUPIED PORTIONS OF THE BUILDING ARE SAFE & AVAILABLE THROUGHOUT CONSTRUCTION.
- CONTRACTOR TO PROVIDE TEMPORARY BARRIERS AT ALL FLOOR PENETRATIONS TO PREVENT PHYSICAL BODILY DAMAGE.
- CONTRACTOR TO PROVIDE A CLEAN JOB SITE FREE FROM DEBRIS THROUGHOUT CONSTRUCTION AT ALL FLOORS.
- VERIFY STAGING AREA, PARKING AVAILABILITY, AND RULES FOR USE WITH PROPERTY OWNER.
- MAINTAIN PROPER EMERGENCY EGRESS AND SYSTEMS THROUGHOUT DEMOLITION AND RENOVATION.
- PATCH ALL FINISHES TO MATCH EXISTING ADJACENT AT ALL DEMOLISHED OR ALTERED BUILDING COMPONENTS UNLESS OTHERWISE NOTED.
- PLUMBING, ELECTRICAL, MECHANICAL, AUDIO/VISUAL, & FIRE ALARM SYSTEMS TO BE DESIGN/BUILD BY CONTRACTOR. IF SHOWN, COMPONENTS OF THESE SYSTEMS ARE DIAGRAMMATIC & PROVIDED FOR PLANNING PURPOSES ONLY. SEE DRAWINGS PROVIDED BY APPROPRIATE SUBCONTRACTOR &/OR LICENSED ENGINEER.
- SEE STRUCTURAL DRAWINGS FOR ALL STRUCTURAL DETAILS & SPECIFICATIONS.
- INSTALL ALL PRODUCTS, COMPONENTS, & SYSTEMS TO MANUFACTURERS RECOMMENDATIONS & PROVIDE ALL ASSEMBLY & INSTALLATION DETAILS IN ORDER TO COMPLY MANUFACTURER WARRANTY REQUIREMENTS.

## **DEMOLITION NOTES**

- PLAN IS A REPRESENTATION OF ESTIMATED WORK TO BE PERFORMED. ADDITIONAL DEMOLITION WORK MAY BE REQUIRED IN ORDER TO CARRY OUT THE WORK DESCRIBED IN THE CONTRACT DOCUMENTS. REVIEW THE CONTRACT DOCUMENTS IN THEIR ENTIRETY AND VISIT THE SITE TO DEVELOP A FULL UNDERSTANDING OF THE WORK TO BE DONE PRIOR TO ISSUANCE OF BID.
- REMOVE DEBRIS FROM SITE IN AN APPROVED MANNER AND AS DIRECTED BY OWNER. VERIFY ALL LOAD BEARING PARTITIONS & STRUCTURAL COMPONENTS PRIOR TO DEMO; NOTIFY ARCHITECT / ENGINEER IF NOT CALLED OUT IN STRUCTURAL DRAWINGS
- VERIFY ALL ALTERATIONS TO EXISTING STRUCTURE W/ STRUCTURAL DRAWINGS
- PROVIDE SHORING AS REQUIRED FOR DEMOLITION OF EXISTING PARTITIONS &/OR STRUCTURAL ELEMENTS AS SHOWN.
- ALERT OWNER IMMEDIATELY UPON FINDING ANY EXISTING CONDITIONS DURING DEMO THAT ARE NOT NOTED ON THE DRAWINGS THAT MAY AFFECT CONSTRUCTION AND/OR DESIGN.
- REMOVE ALL ABANDONED AND/OR OBSOLETE MISCELLANEOUS ITEMS, CABLING, WIRING, PLUMBING & OTHER UTILITY COMPONENTS THROUGHOUT THE WORK AREA. INCLUDING ABOVE THE CEILING. ONCE VERIFIED AS DISCONNECTED & OBSOLETE.
- REMOVE ALL MECHANICAL, ELECTRICAL, PLUMBING, COMMUNICATION SYSTEMS, & COMPONENTS THAT ARE OBSOLETE. ABANDONED, OR TO BE REPLACED WITH NEW COMPONENTS BACK TO SOURCE. REFER TO MEP-FA DRAWINGS.
- REMOVE SWITCHES, CONTROLS, ETC, THAT ARE TO BE DISCONNECTED. WHERE RECEPTACLES OR SWITCHES ARE TO BE REMOVED OR RELOCATED, ABANDONMENT AND CAP PLATES ARE NOT ACCEPTABLE. REMOVE ALL INFRASTRUCTURE BACK TO SOURCE & PATCH WALL TO MATCH EXISTING WALL CONDITION.
- ALL EXISTING EQUIPMENT THAT REMAINS IN PLACE AND/OR OPERATIONAL DURING THE PROJECT SHALL BE PROTECTED. • ALL EXISTING CONDITIONS TO REMAIN SHALL BE PROTECTED. WHERE DEMOLITION ABUTS EXISTING MATERIAL TO REMAIN,
- PATCH ANY DAMAGES TO MATCH EXISTING ADJACENT SURFACES.
- COORDINATE REMOVAL OF SALVAGED ITEMS WITH OWNER.
- REMOVE ASSOCIATED DOORS, WINDOWS, & ELECTRICAL TEL-DATA WHEN REMOVING INTERIOR PARTITIONS.
- COORDINATE DEMO OF WALLS WITH EXISTING EQUIPMENT TO REMAIN. REFER TO MEP-FA DRAWINGS.
- STRIP EXISTING WALL COVERINGS AT ALL LOCATIONS SCHEDULED TO RECEIVE NEW FINISH.

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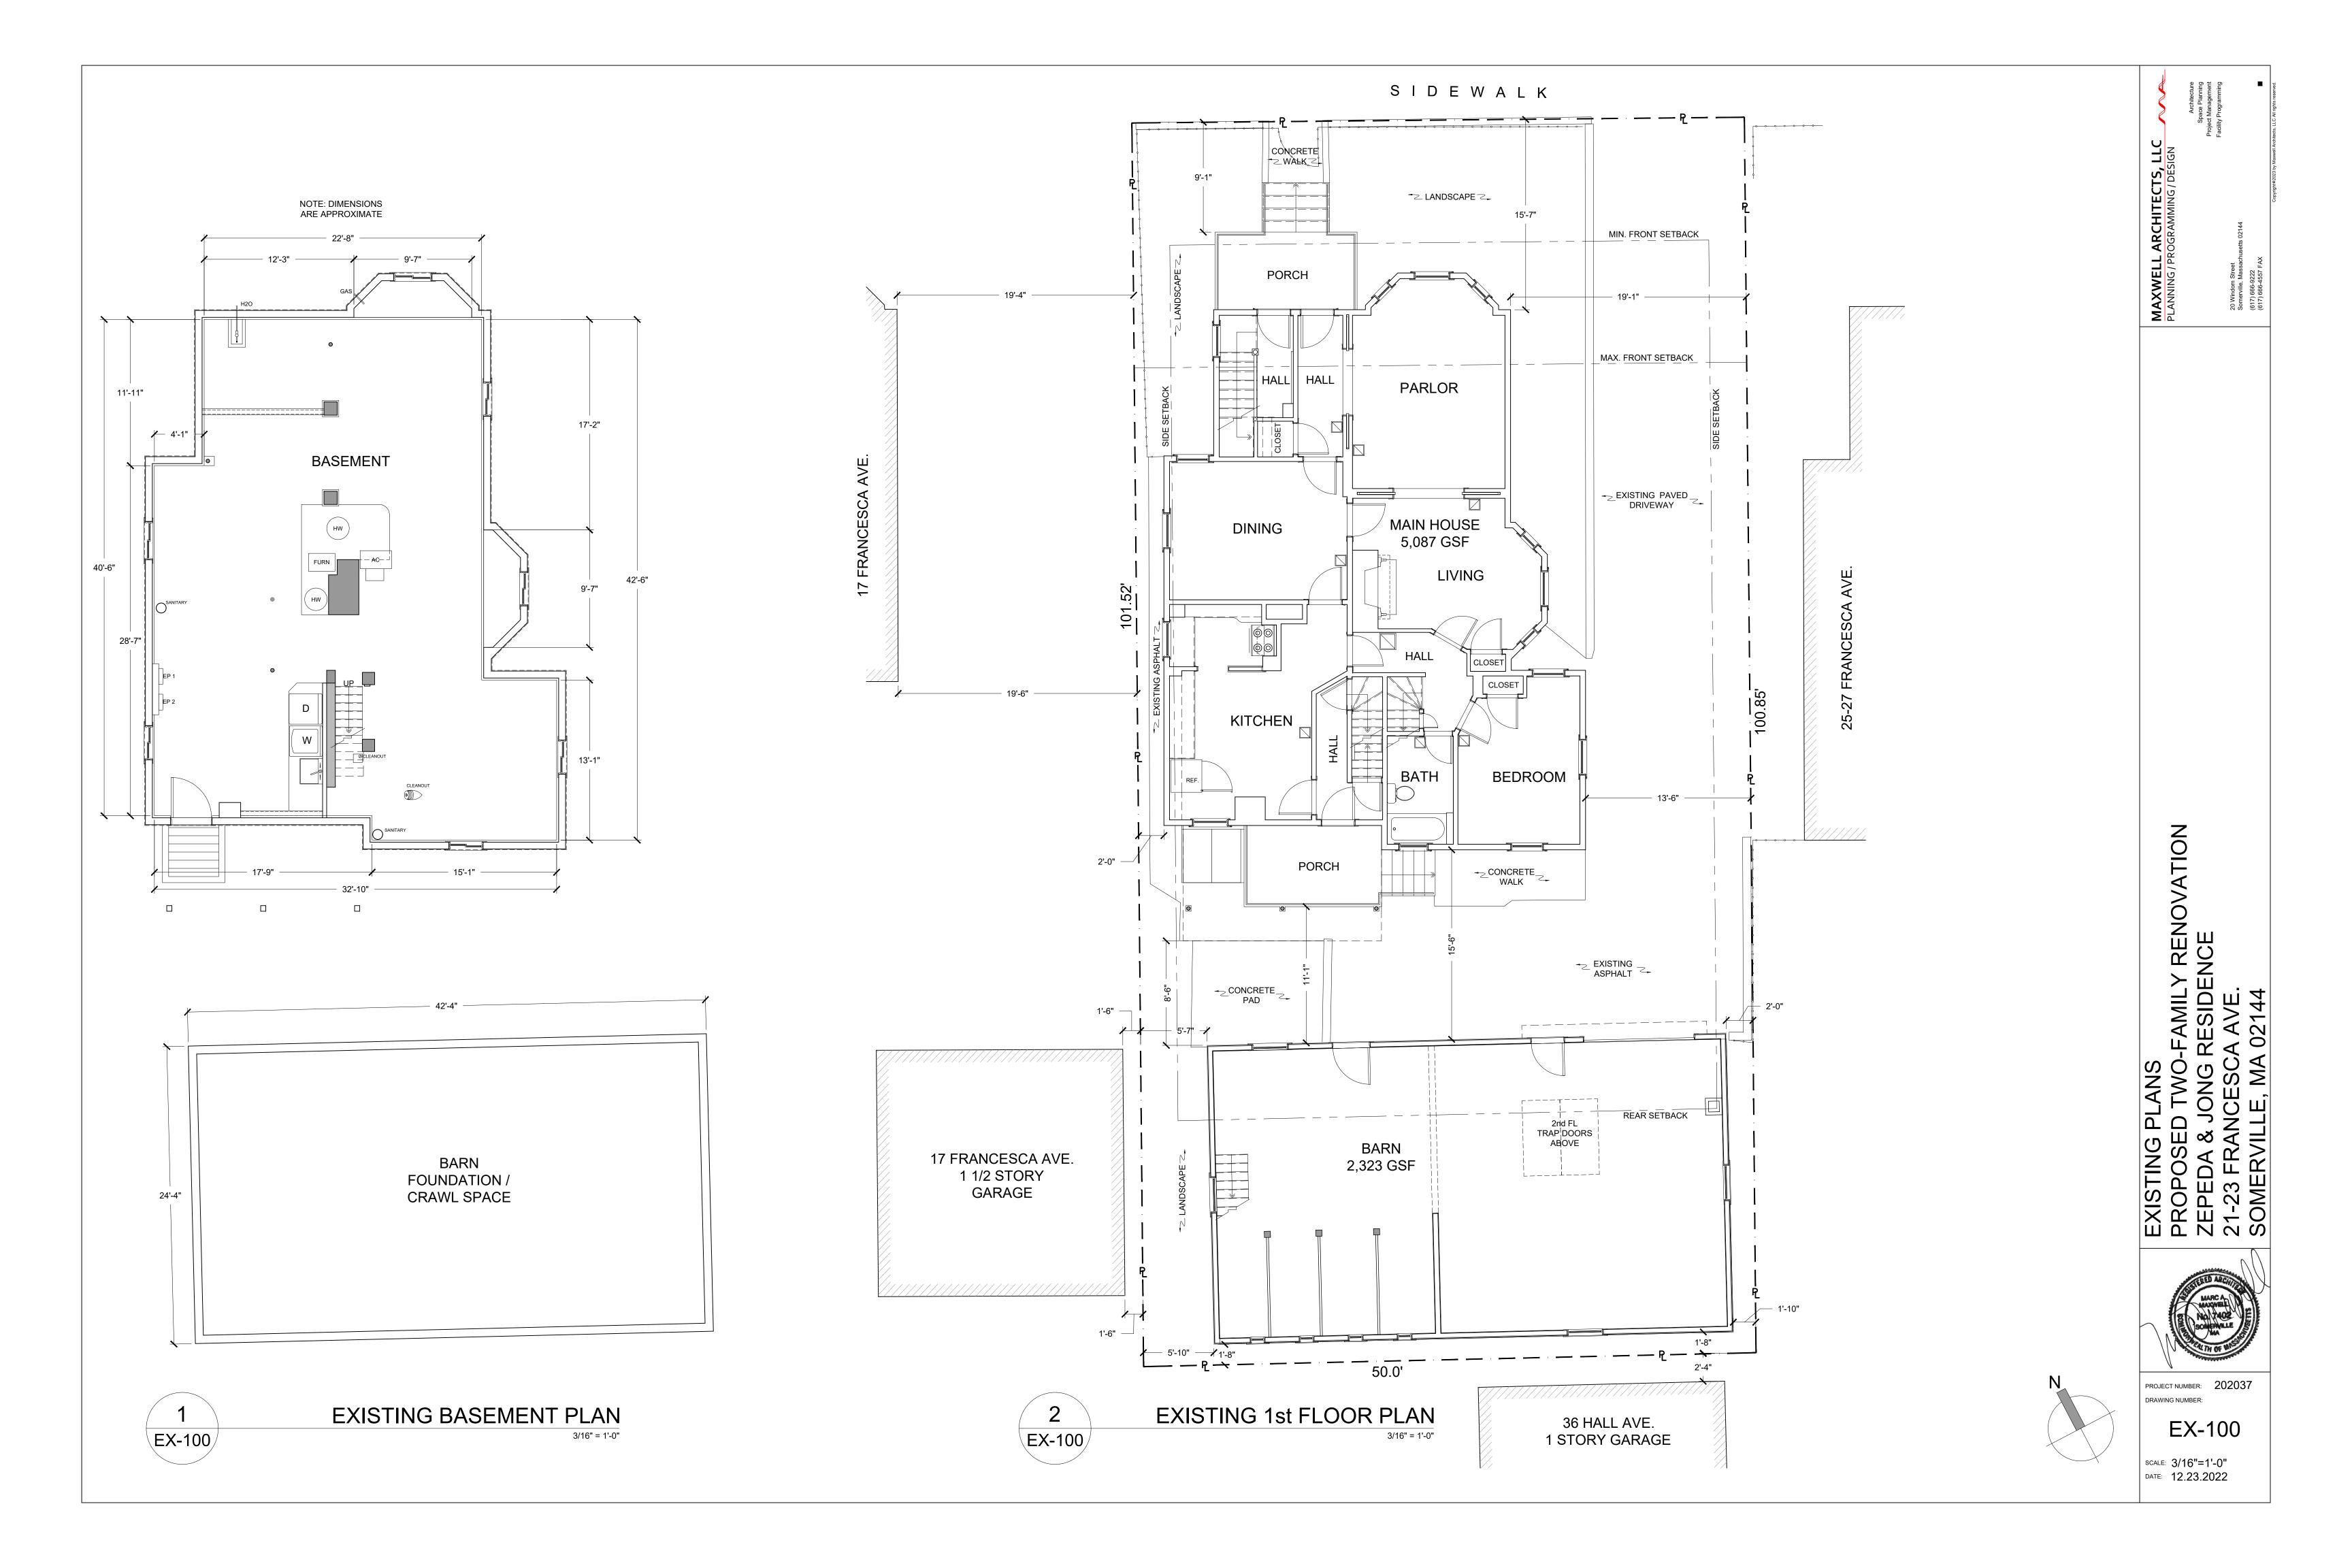
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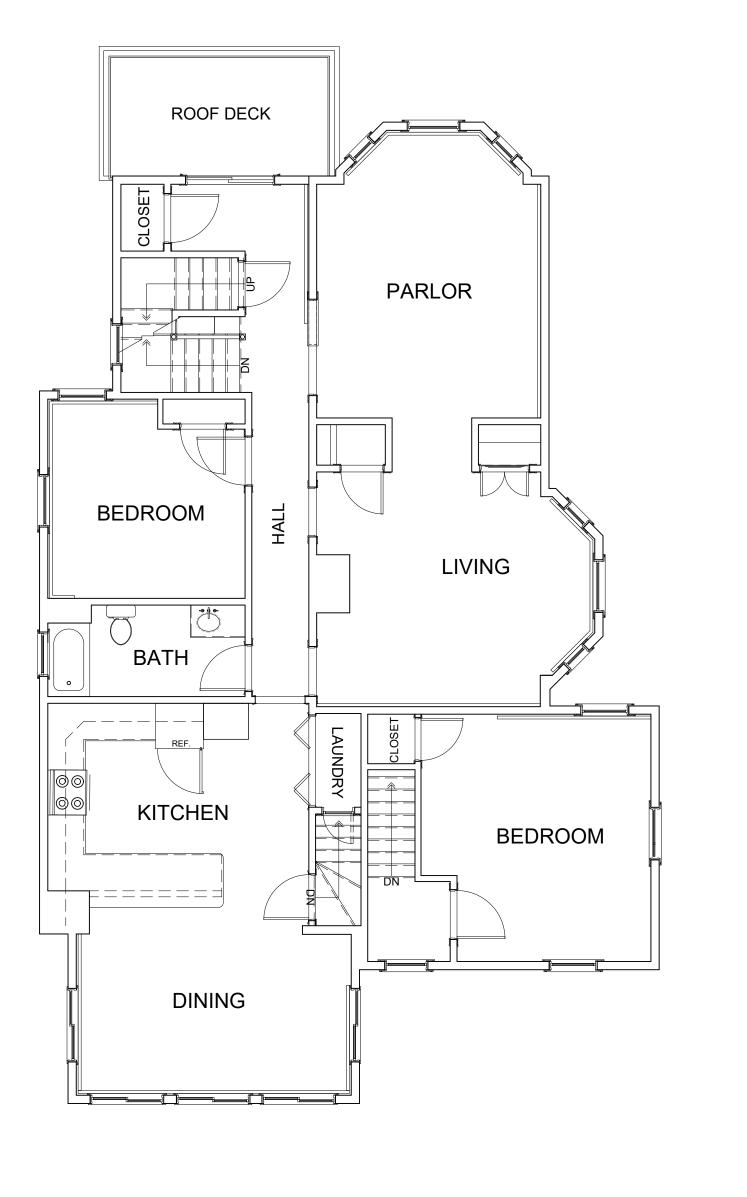
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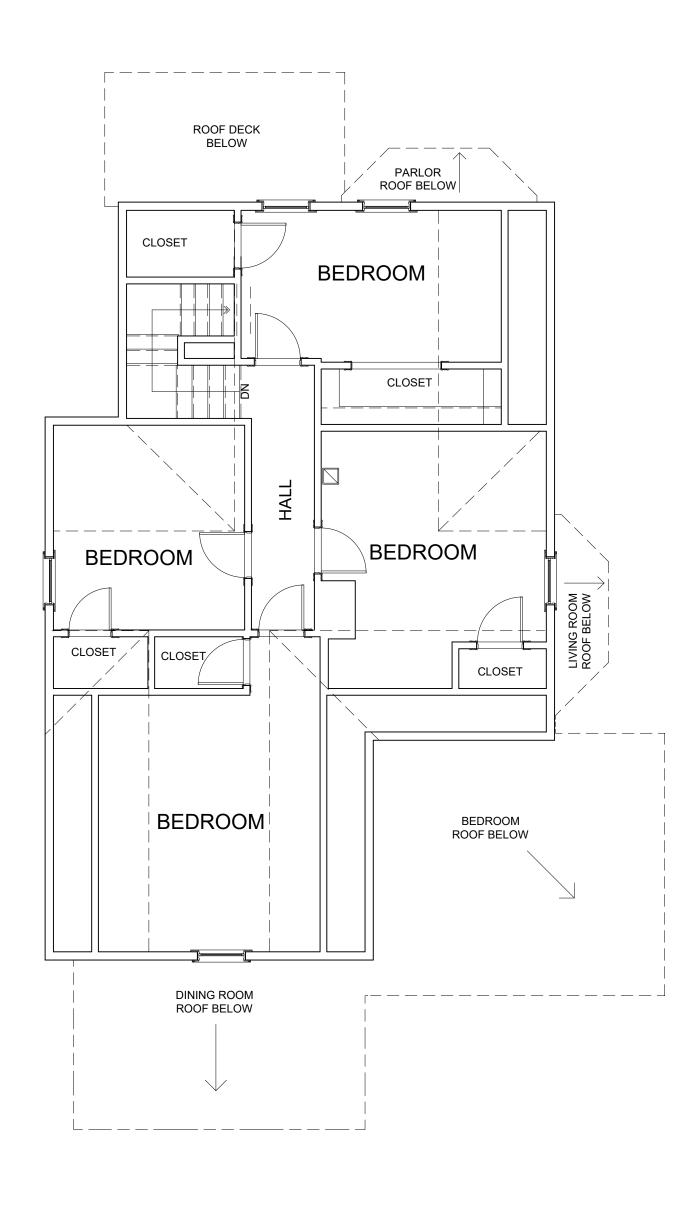
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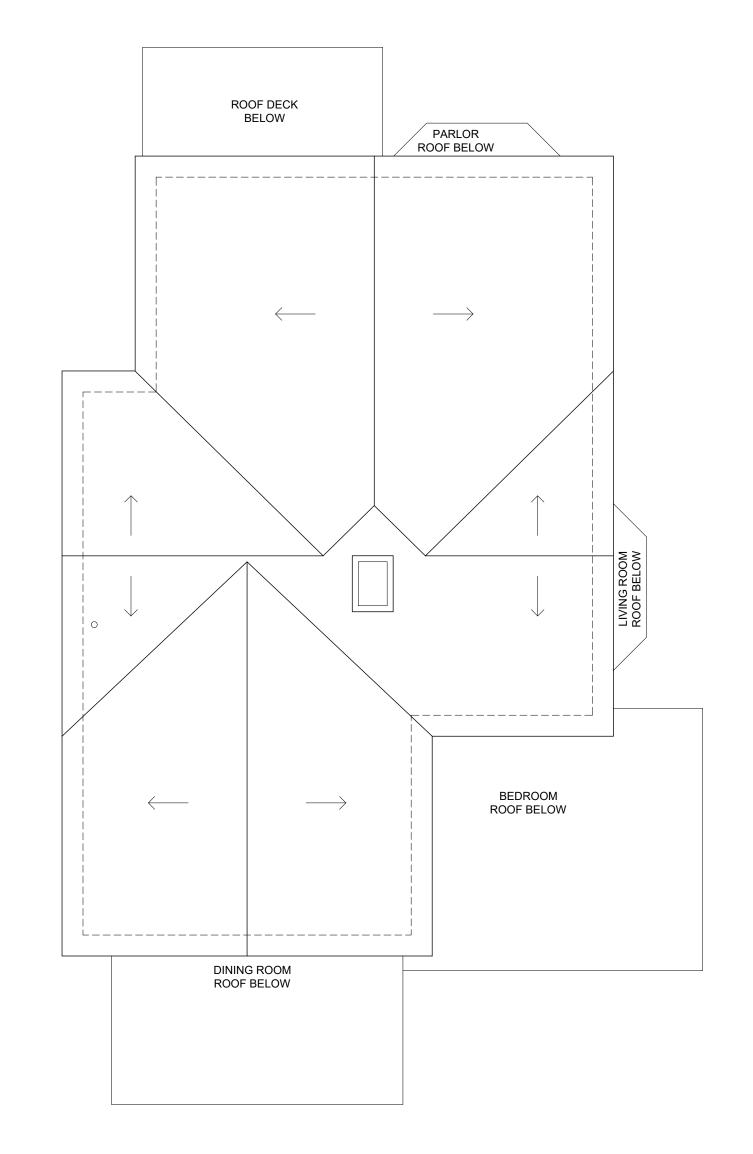
T-101


SCALE: AS NOTED DATE: 12.23.2022











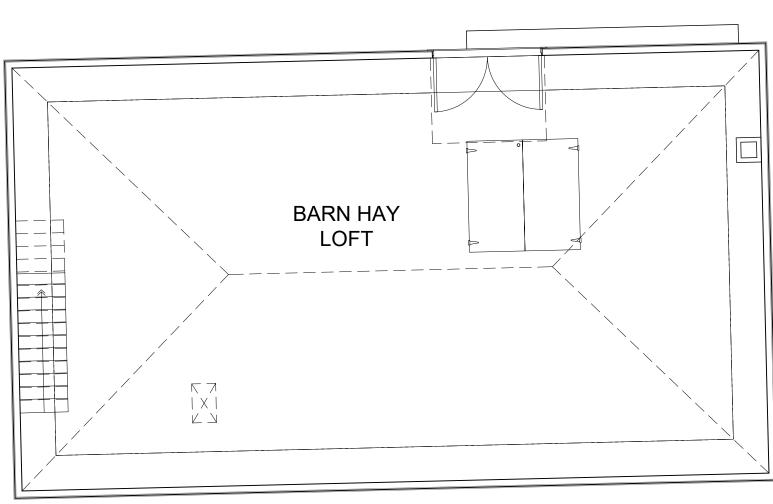

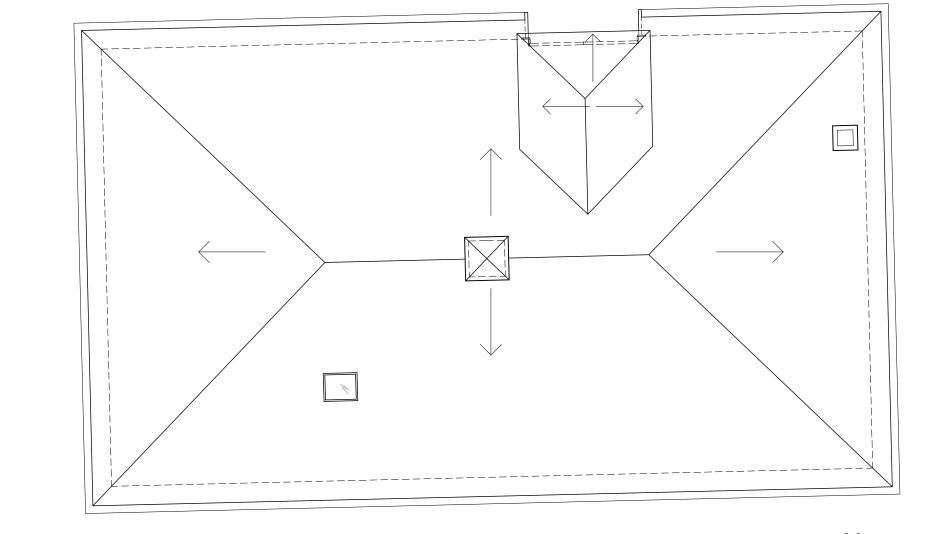

EX-101/

EXISTING ROOF PLAN

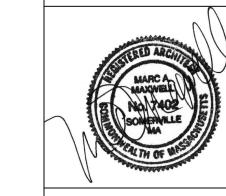

EXIST PROP ZEPEI 21-23 SOME

PROJECT NUMBER: 202037

EX-101

SCALE: 3/16"=1'-0"
DATE: 12.23.2022

EXISTING 2nd FLOOR PLAN
3/16" = 1'-0"

EX-101

EXISTING 3rd FLOOR PLAN





EXISTING PRIMARY STRUCTURE ELEVATION
PROPOSED TWO-FAMILY RENOVATION
ZEPEDA & JONG RESIDENCE
21-23 FRANCESCA AVE.
SOMERVILLE, MA 02144

PROJECT NUMBER: 202037

EX-201



EXISTING BACKYARD COTTAGE ELEVATIONS
PROPOSED TWO-FAMILY RENOVATION
ZEPEDA & JONG RESIDENCE

MARCA MARCA

PROJECT NUMBER: 20203
DRAWING NUMBER:


EX-202




EXISTING BACKYARD COTTAGE ELEVATIONS
PROPOSED TWO-FAMILY RENOVATION
ZEPEDA & JONG RESIDENCE
21-23 FRANCESCA AVE.
SOMERVILLE, MA 02144

PROJECT NUMBER: 20203
DRAWING NUMBER:


EX-203

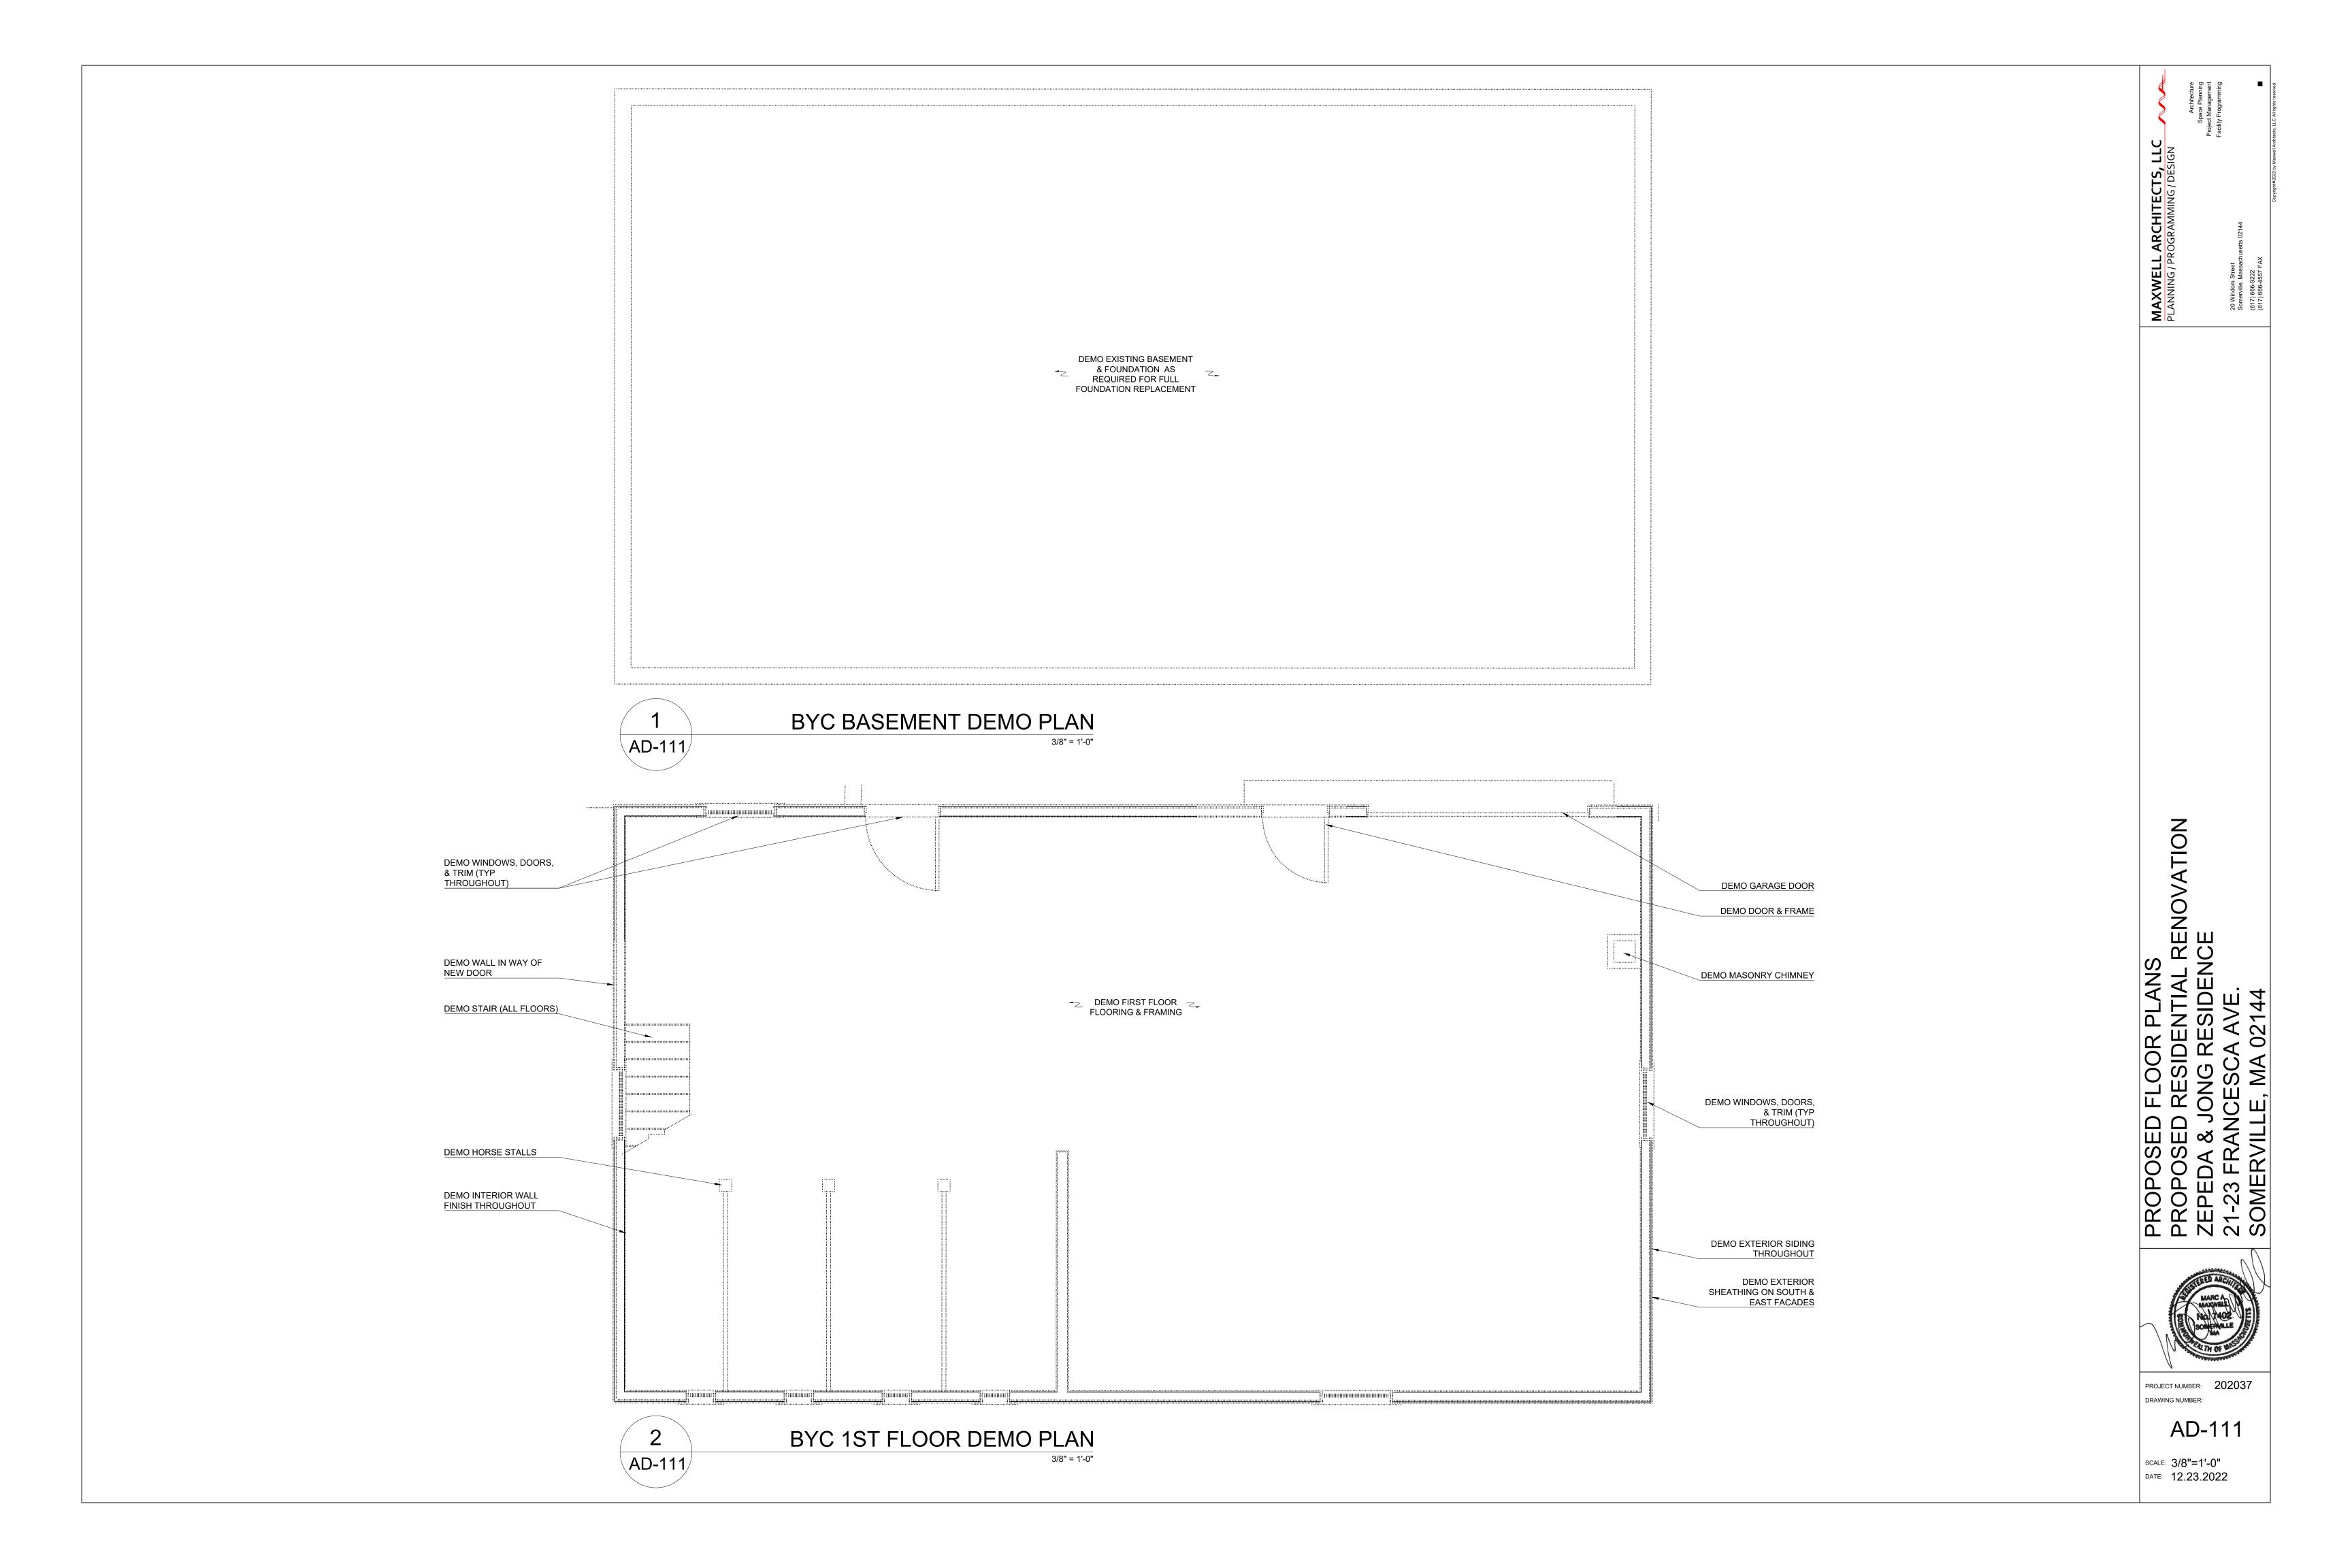

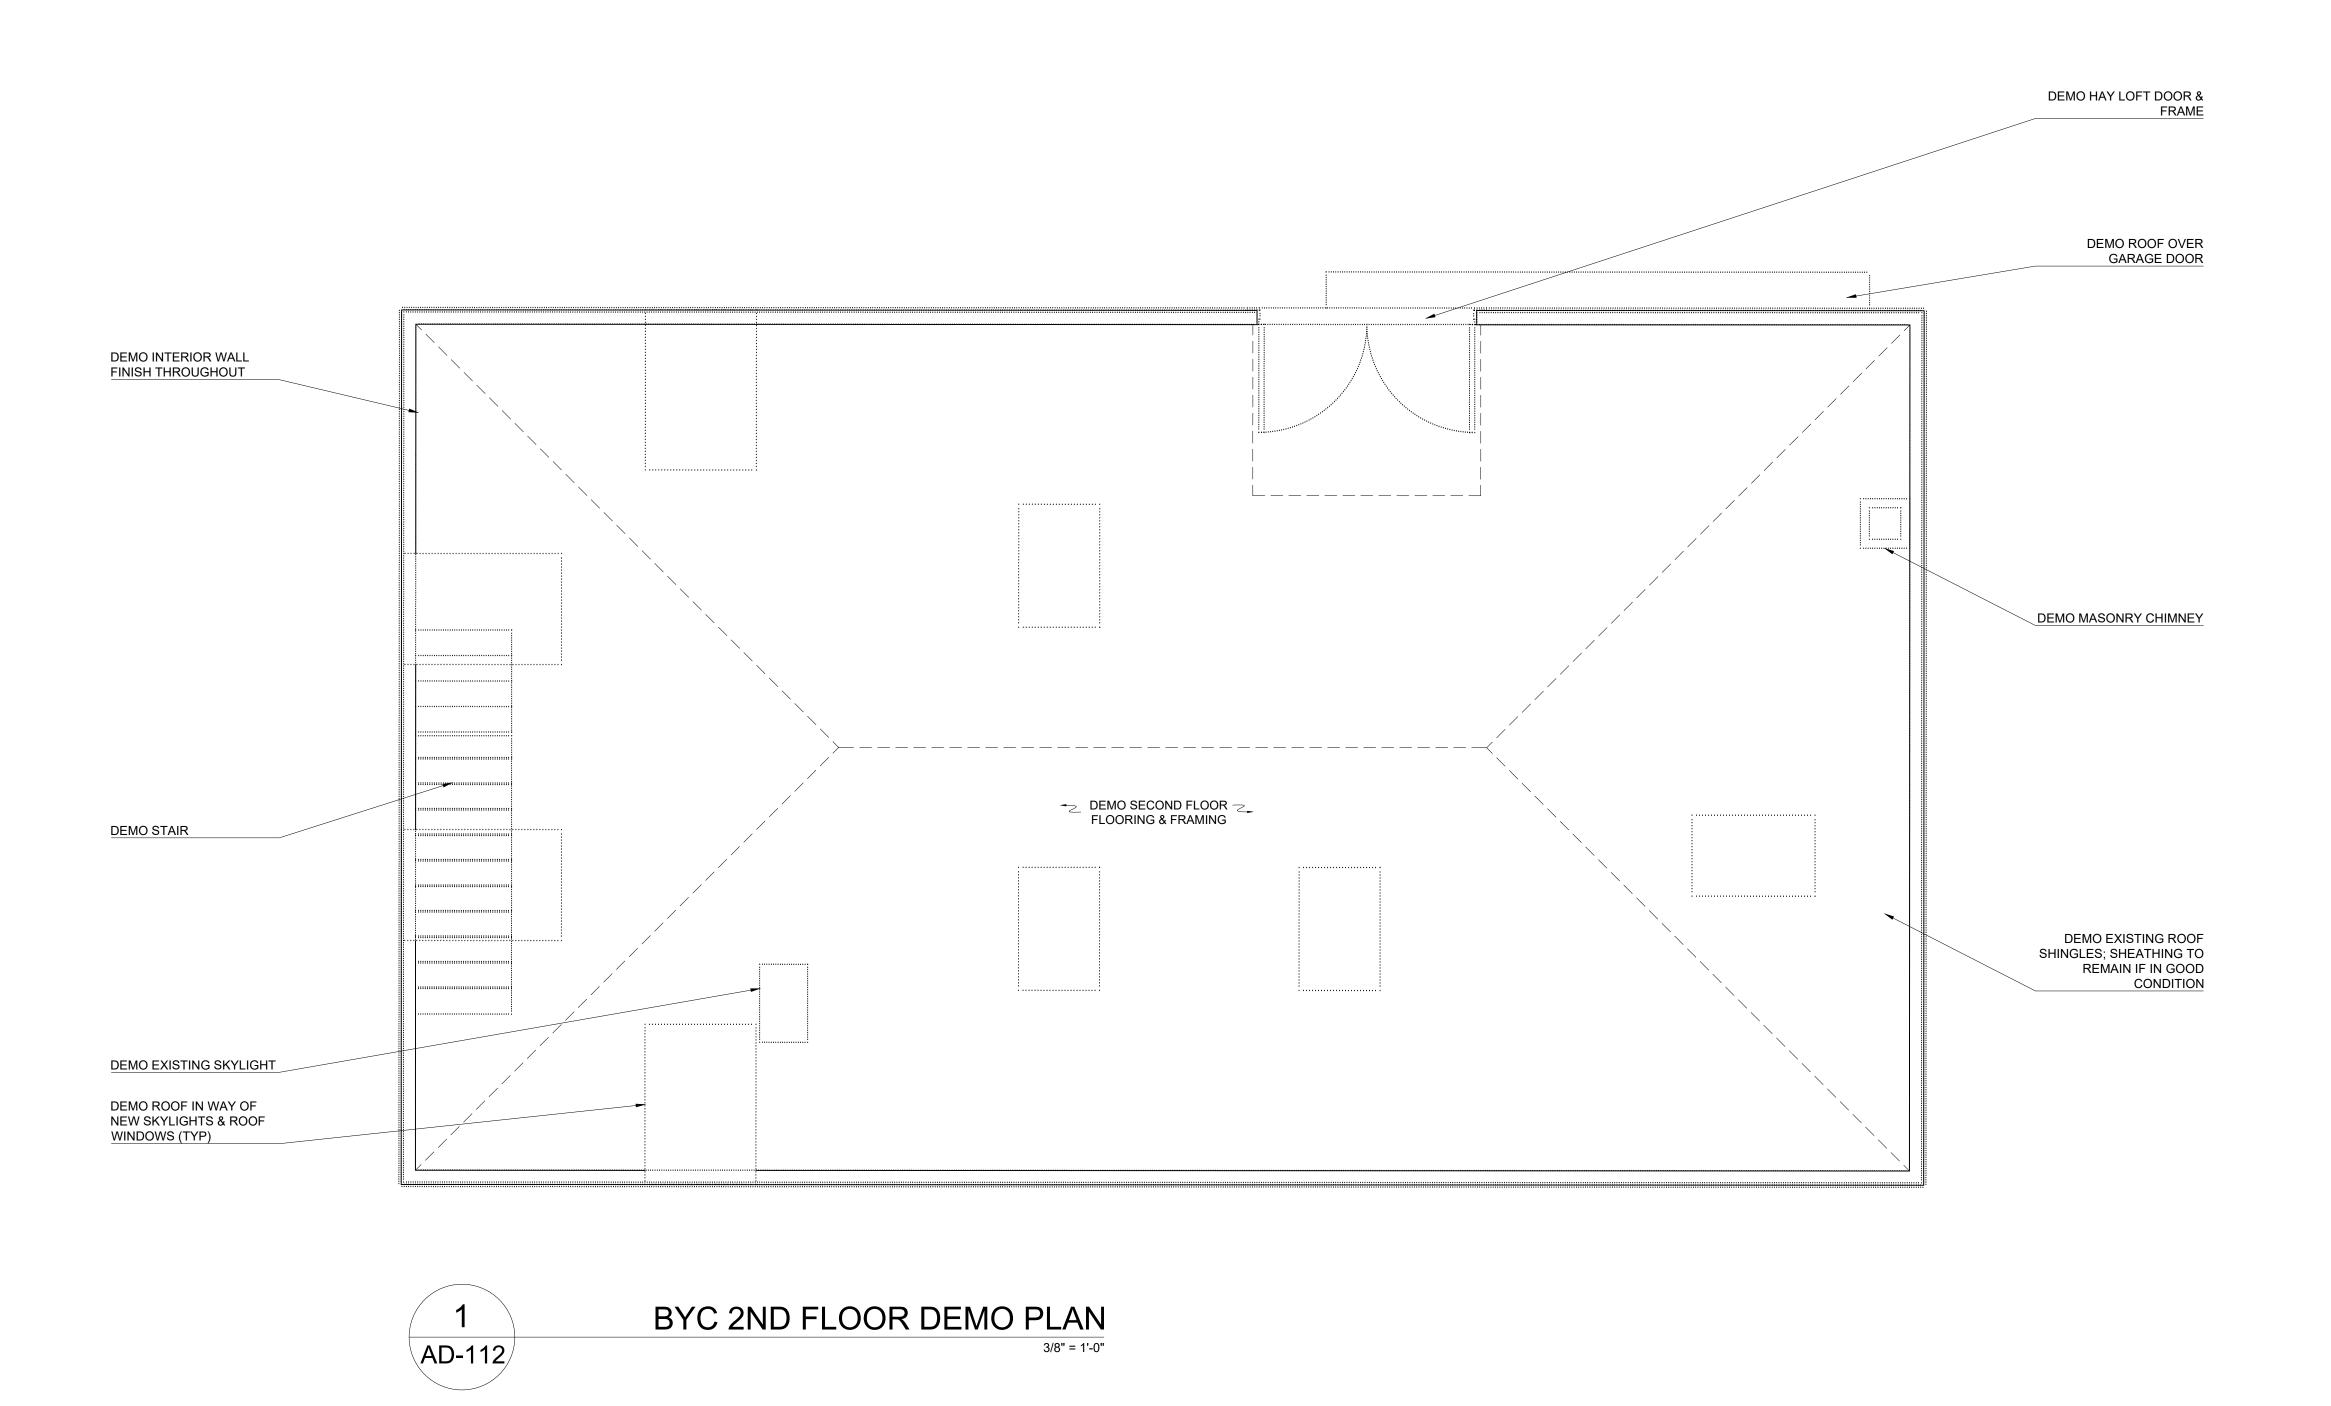


PROPOSED FLOOR PLANS
PROPOSED RESIDENTIAL RENOVATION
ZEPEDA & JONG RESIDENCE
21-23 FRANCESCA AVE.
SOMERVILLE, MA 02144


MAXWELL ARCHITECTS, LLC PLANNING / PROGRAMMING / DESIGN

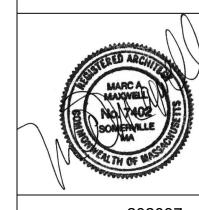


PROJECT NUMBER: 202037 DRAWING NUMBER:

AD-112

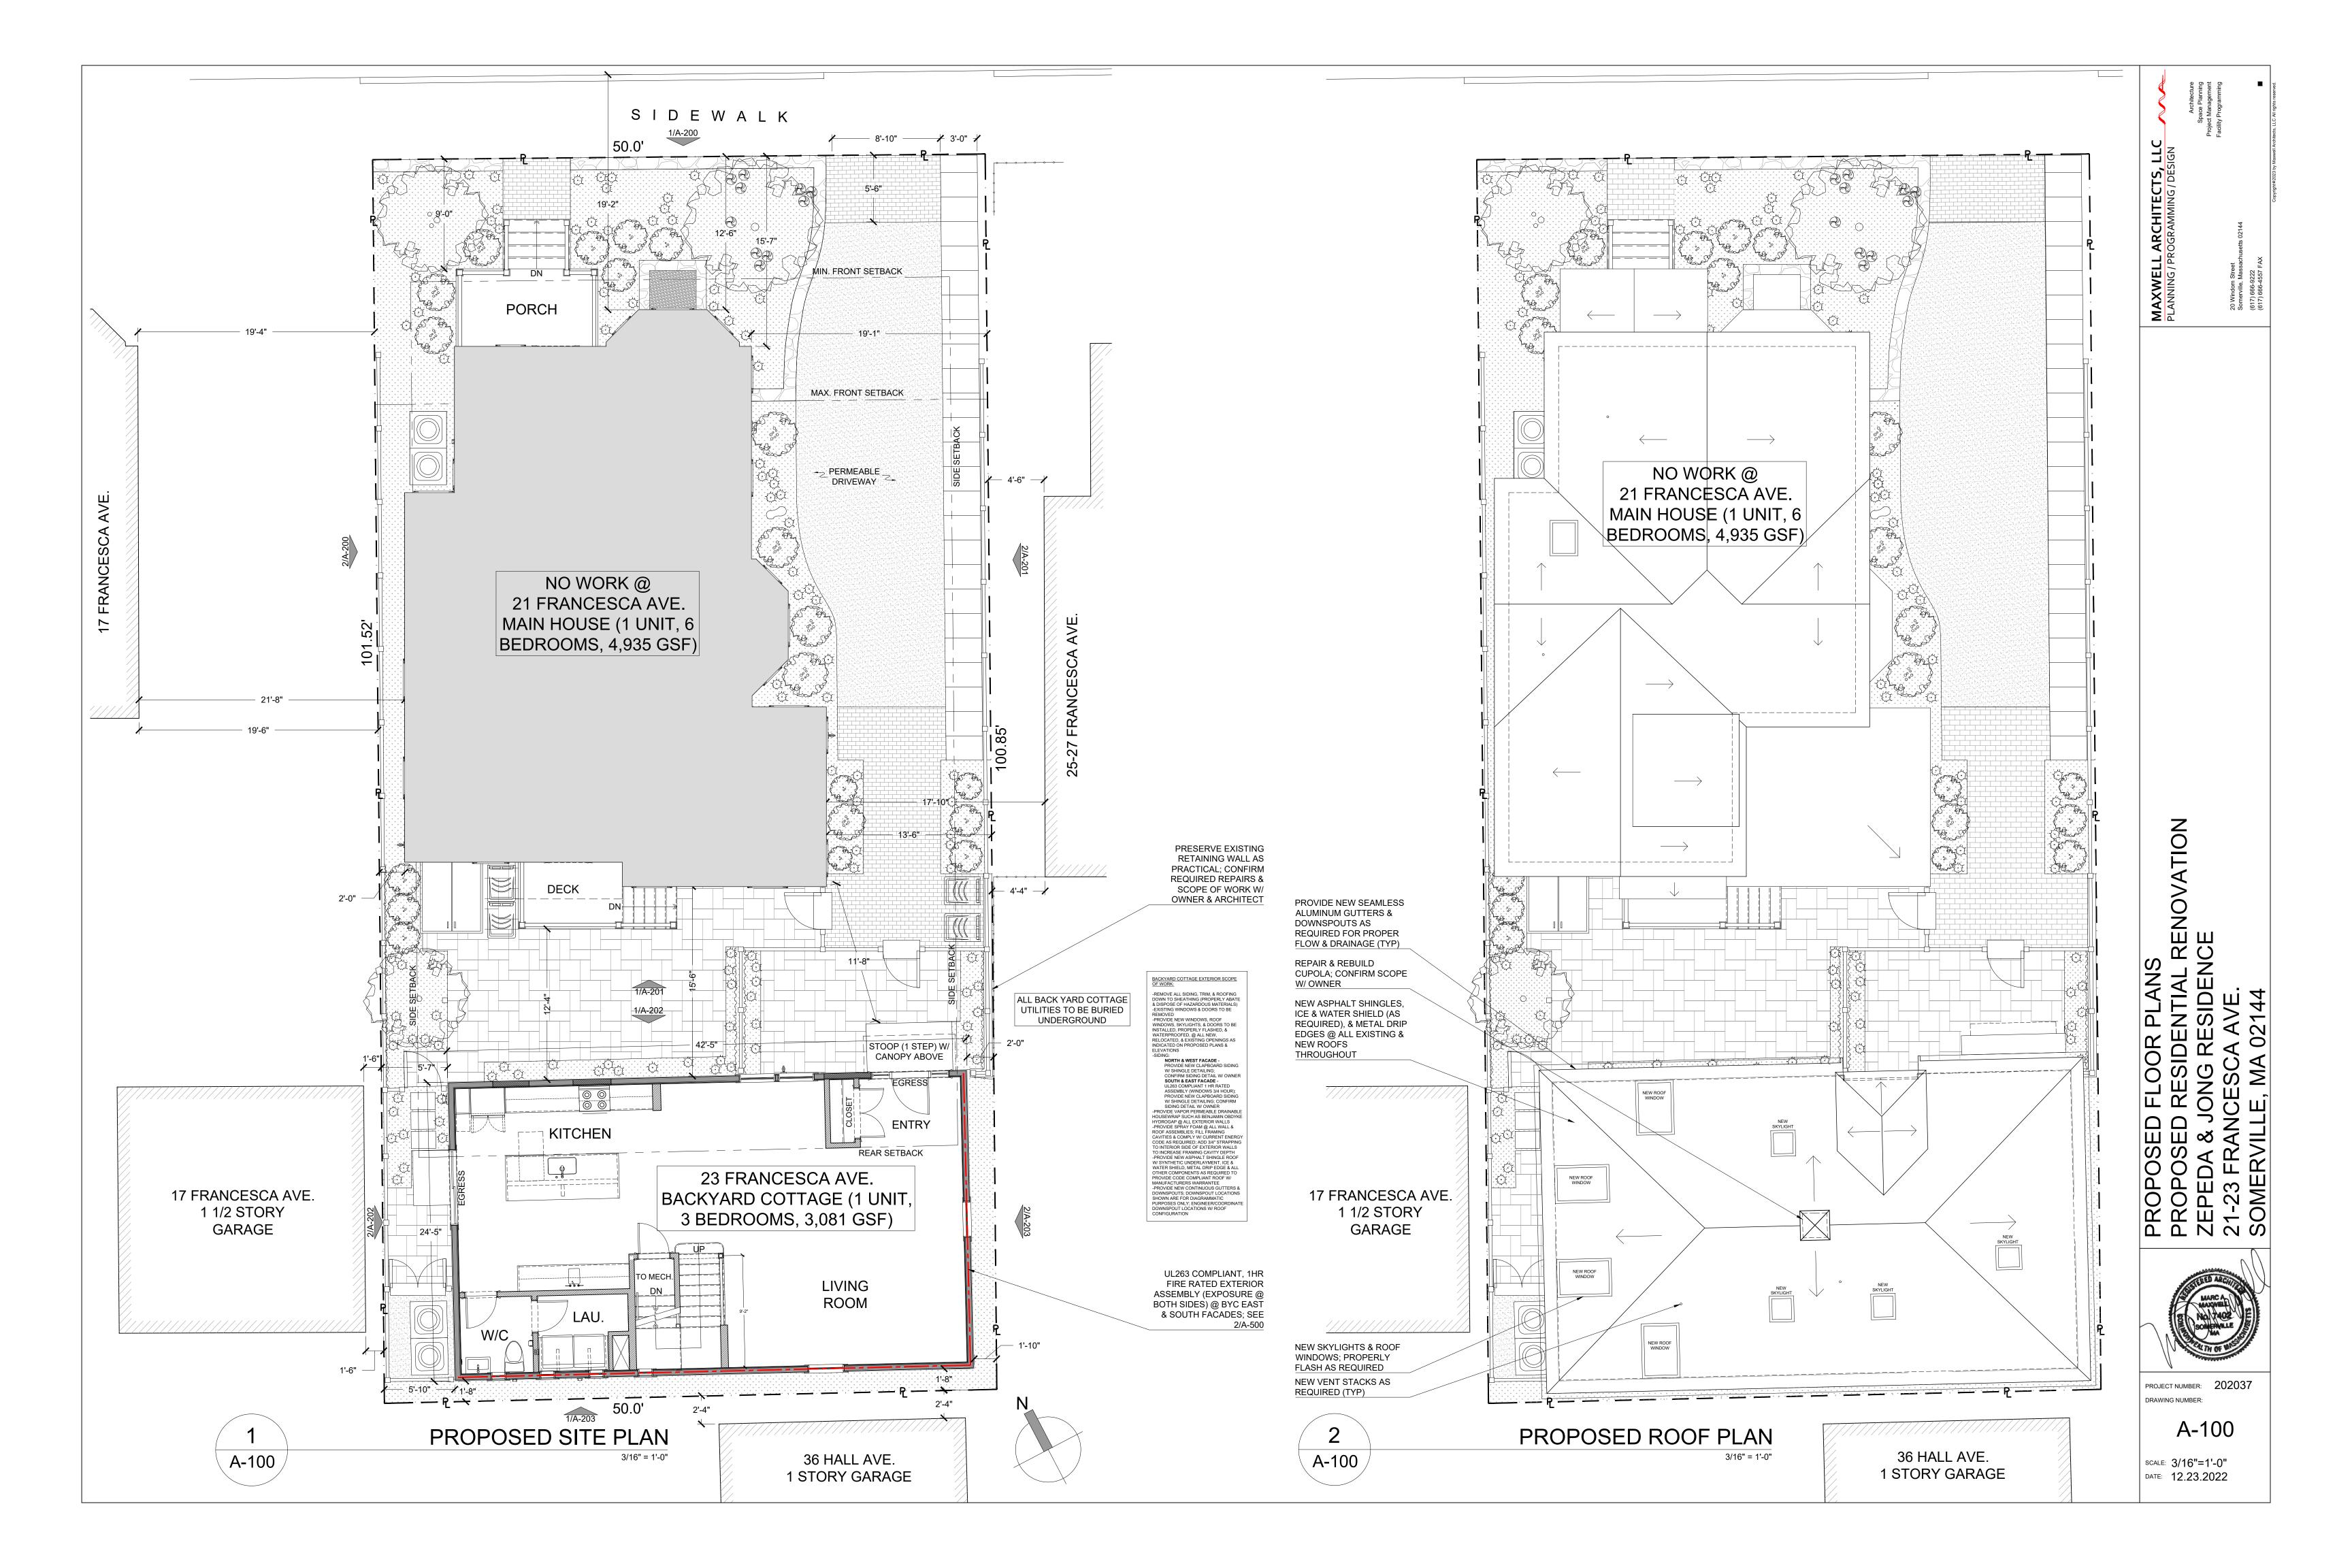

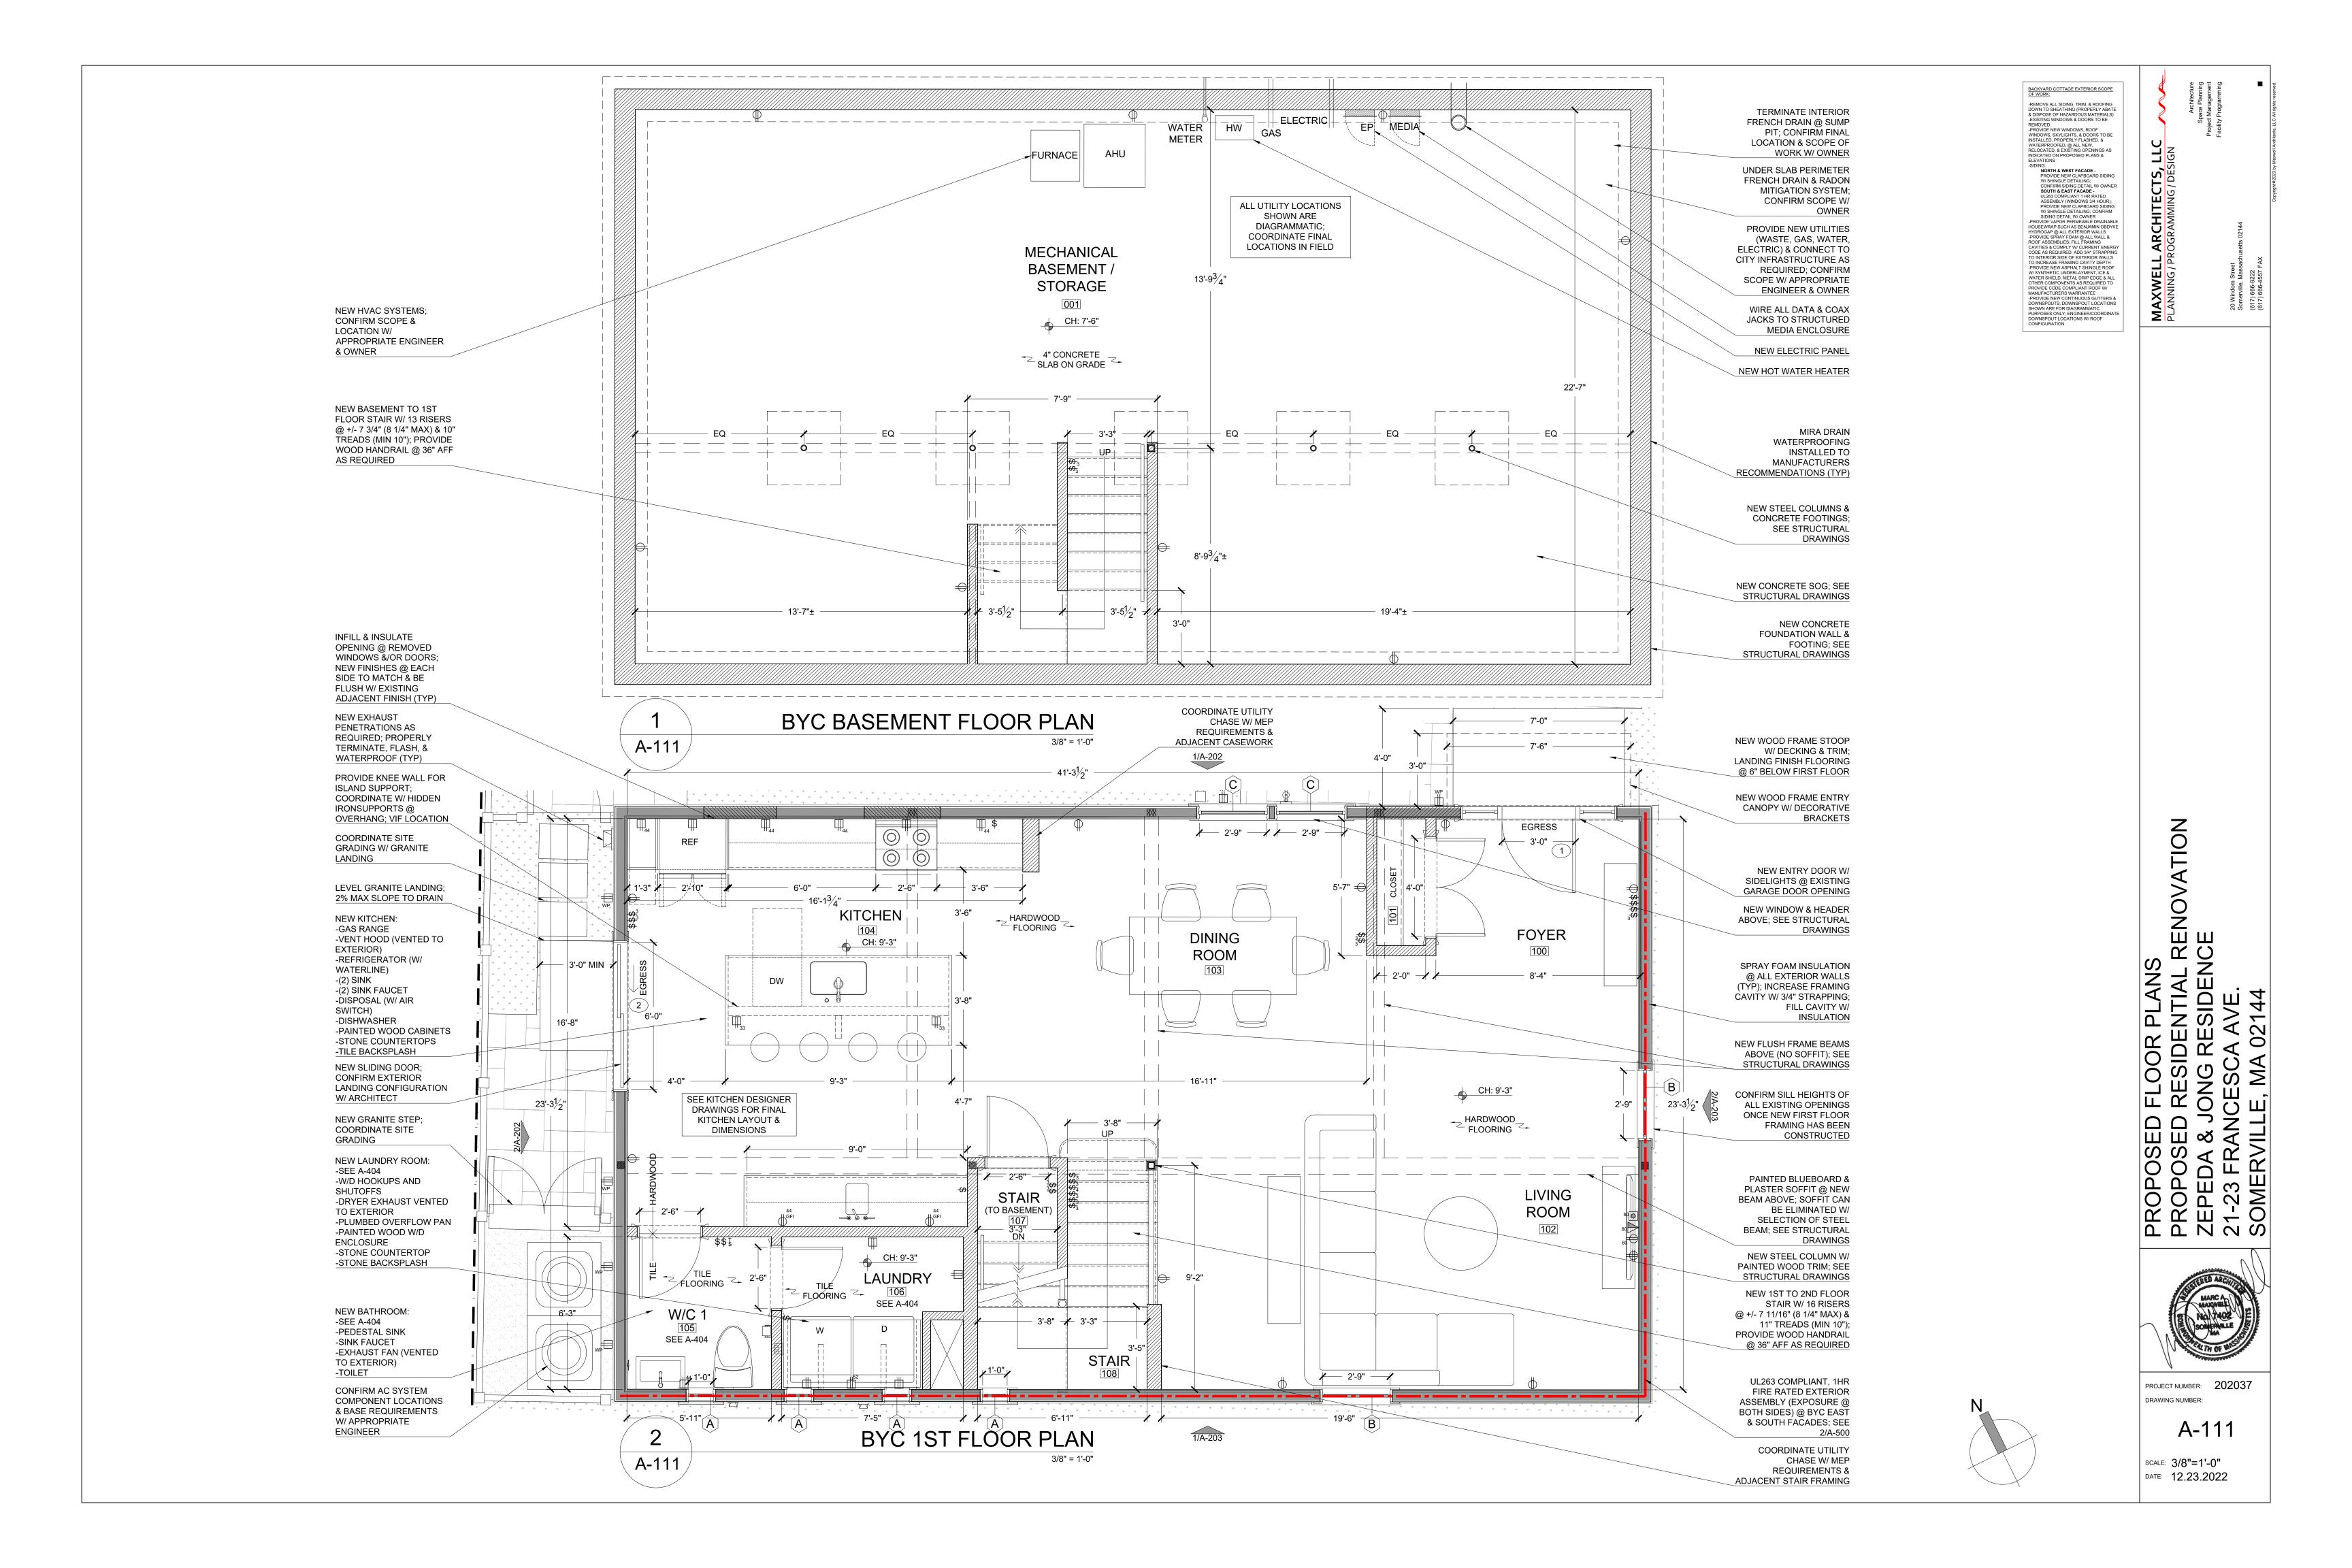

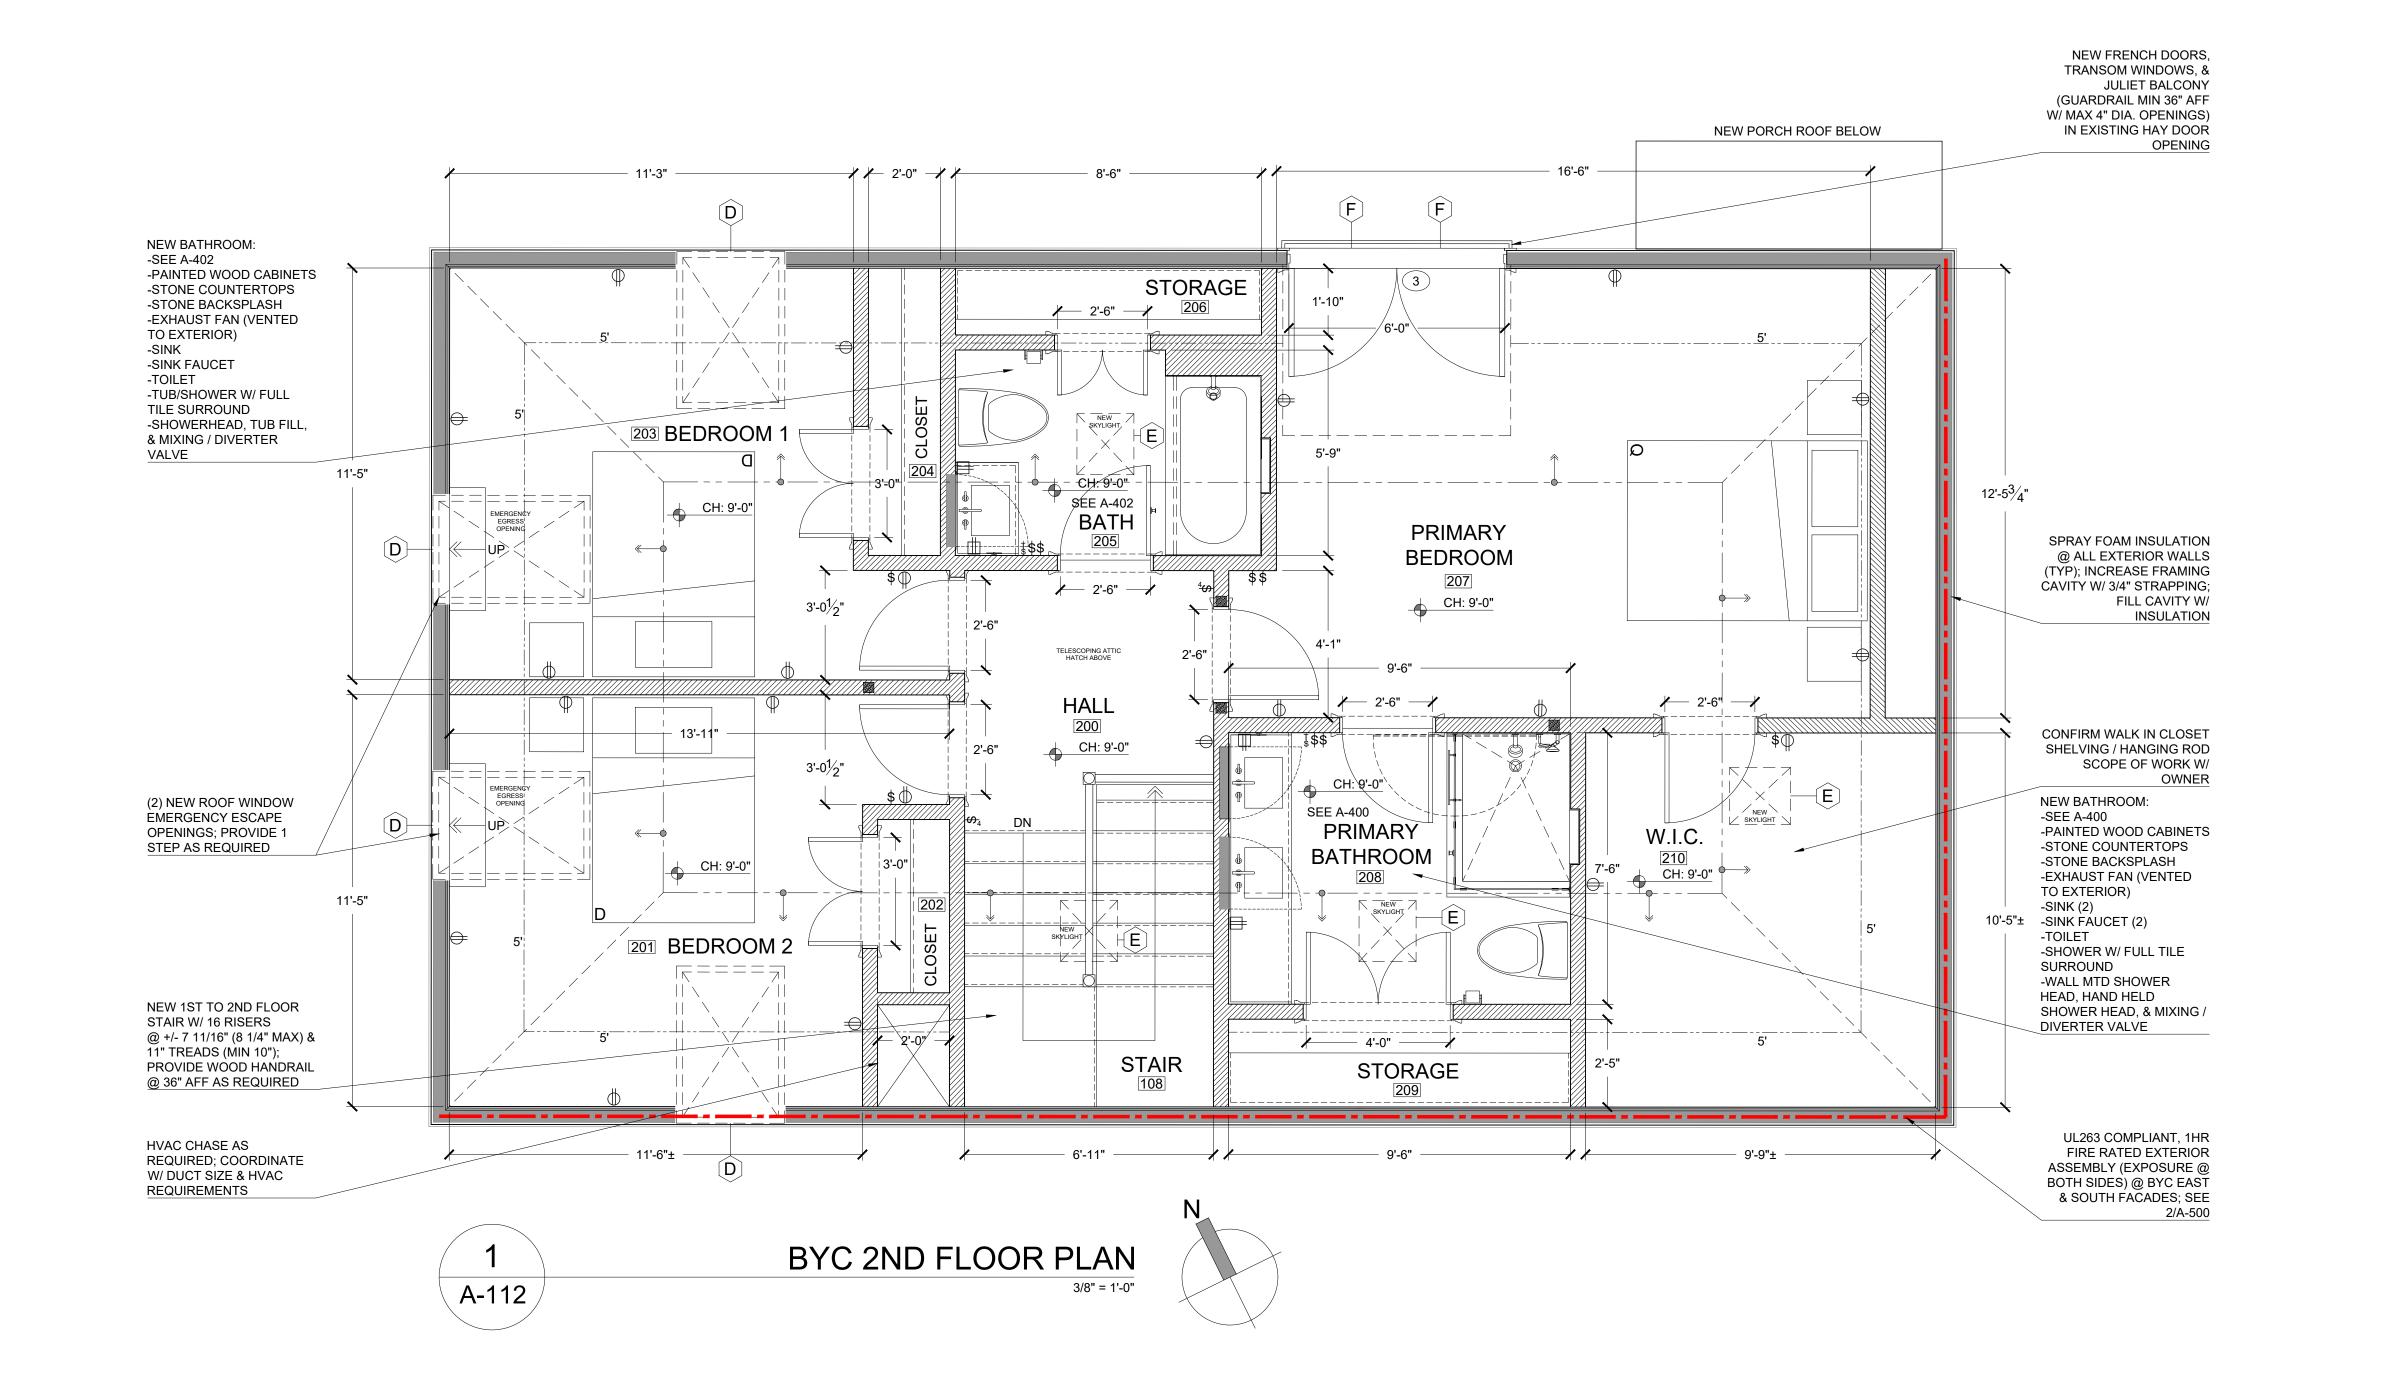

BACKYARD COTTAGE EXTERIOR SCOPE OF WORK:

EMERGENCY EGRESS OPENINGS

IF DOUBLE OR SINGLE HUNG: - 3.3 SF MIN OPENING AREA - 24" & 20" MIN OPENING DIMENSIONS CAN BE IN EITHER DIRECTION - 44" MAX SILL HEIGHT

ANY OTHER APPROVED WINDOW TYPE:
-5.7 SF(5.0 SF IF BELOW GRADE) MIN
OPENING AREA
-24" MIN OPENING HEIGHT
-20" MIN OPENING WIDTH
-44" MAX SILL HEIGHT

SEE IRC 2015 SECTION R310 & MA AMENDMENTS FOR REQUIREMENTS EMERGENCY EGRESS WINDOW WELLS

- 36" MIN WIDTH & PROJECTION
- 9 SF MIN FOOTPRINT
- LADDER/STEPS NOT REQUIRED IF WELL
HEIGHT IS LESS THAN 44"
- TIE INTO FOUNDATION DRAINAGE
SYSTEM OR APPROVED ALTERNATE
- 36" MIN HEAD HEIGHT ABOVE WELL

-MAX ALLOWABLE CEILING HEIGHT TO BE 12'-0"


-ROOF RAFTERS TO INTERSECT THE WALL PLATE @ MAX 2'-0" AFF

SEE IRC 2015 SECTION R310 & MA AMENDMENTS FOR REQUIREMENTS

. ARCHITECTS, I ROGRAMMING/DESI


MAXWELL A

PROPOSED FLOOR PLANS
PROPOSED RESIDENTIAL RENOVATION
ZEPEDA & JONG RESIDENCE
21-23 FRANCESCA AVE.
SOMERVILLE, MA 02144

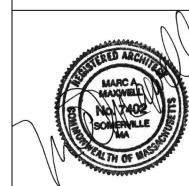


PROJECT NUMBER: 202037 DRAWING NUMBER:

A-112

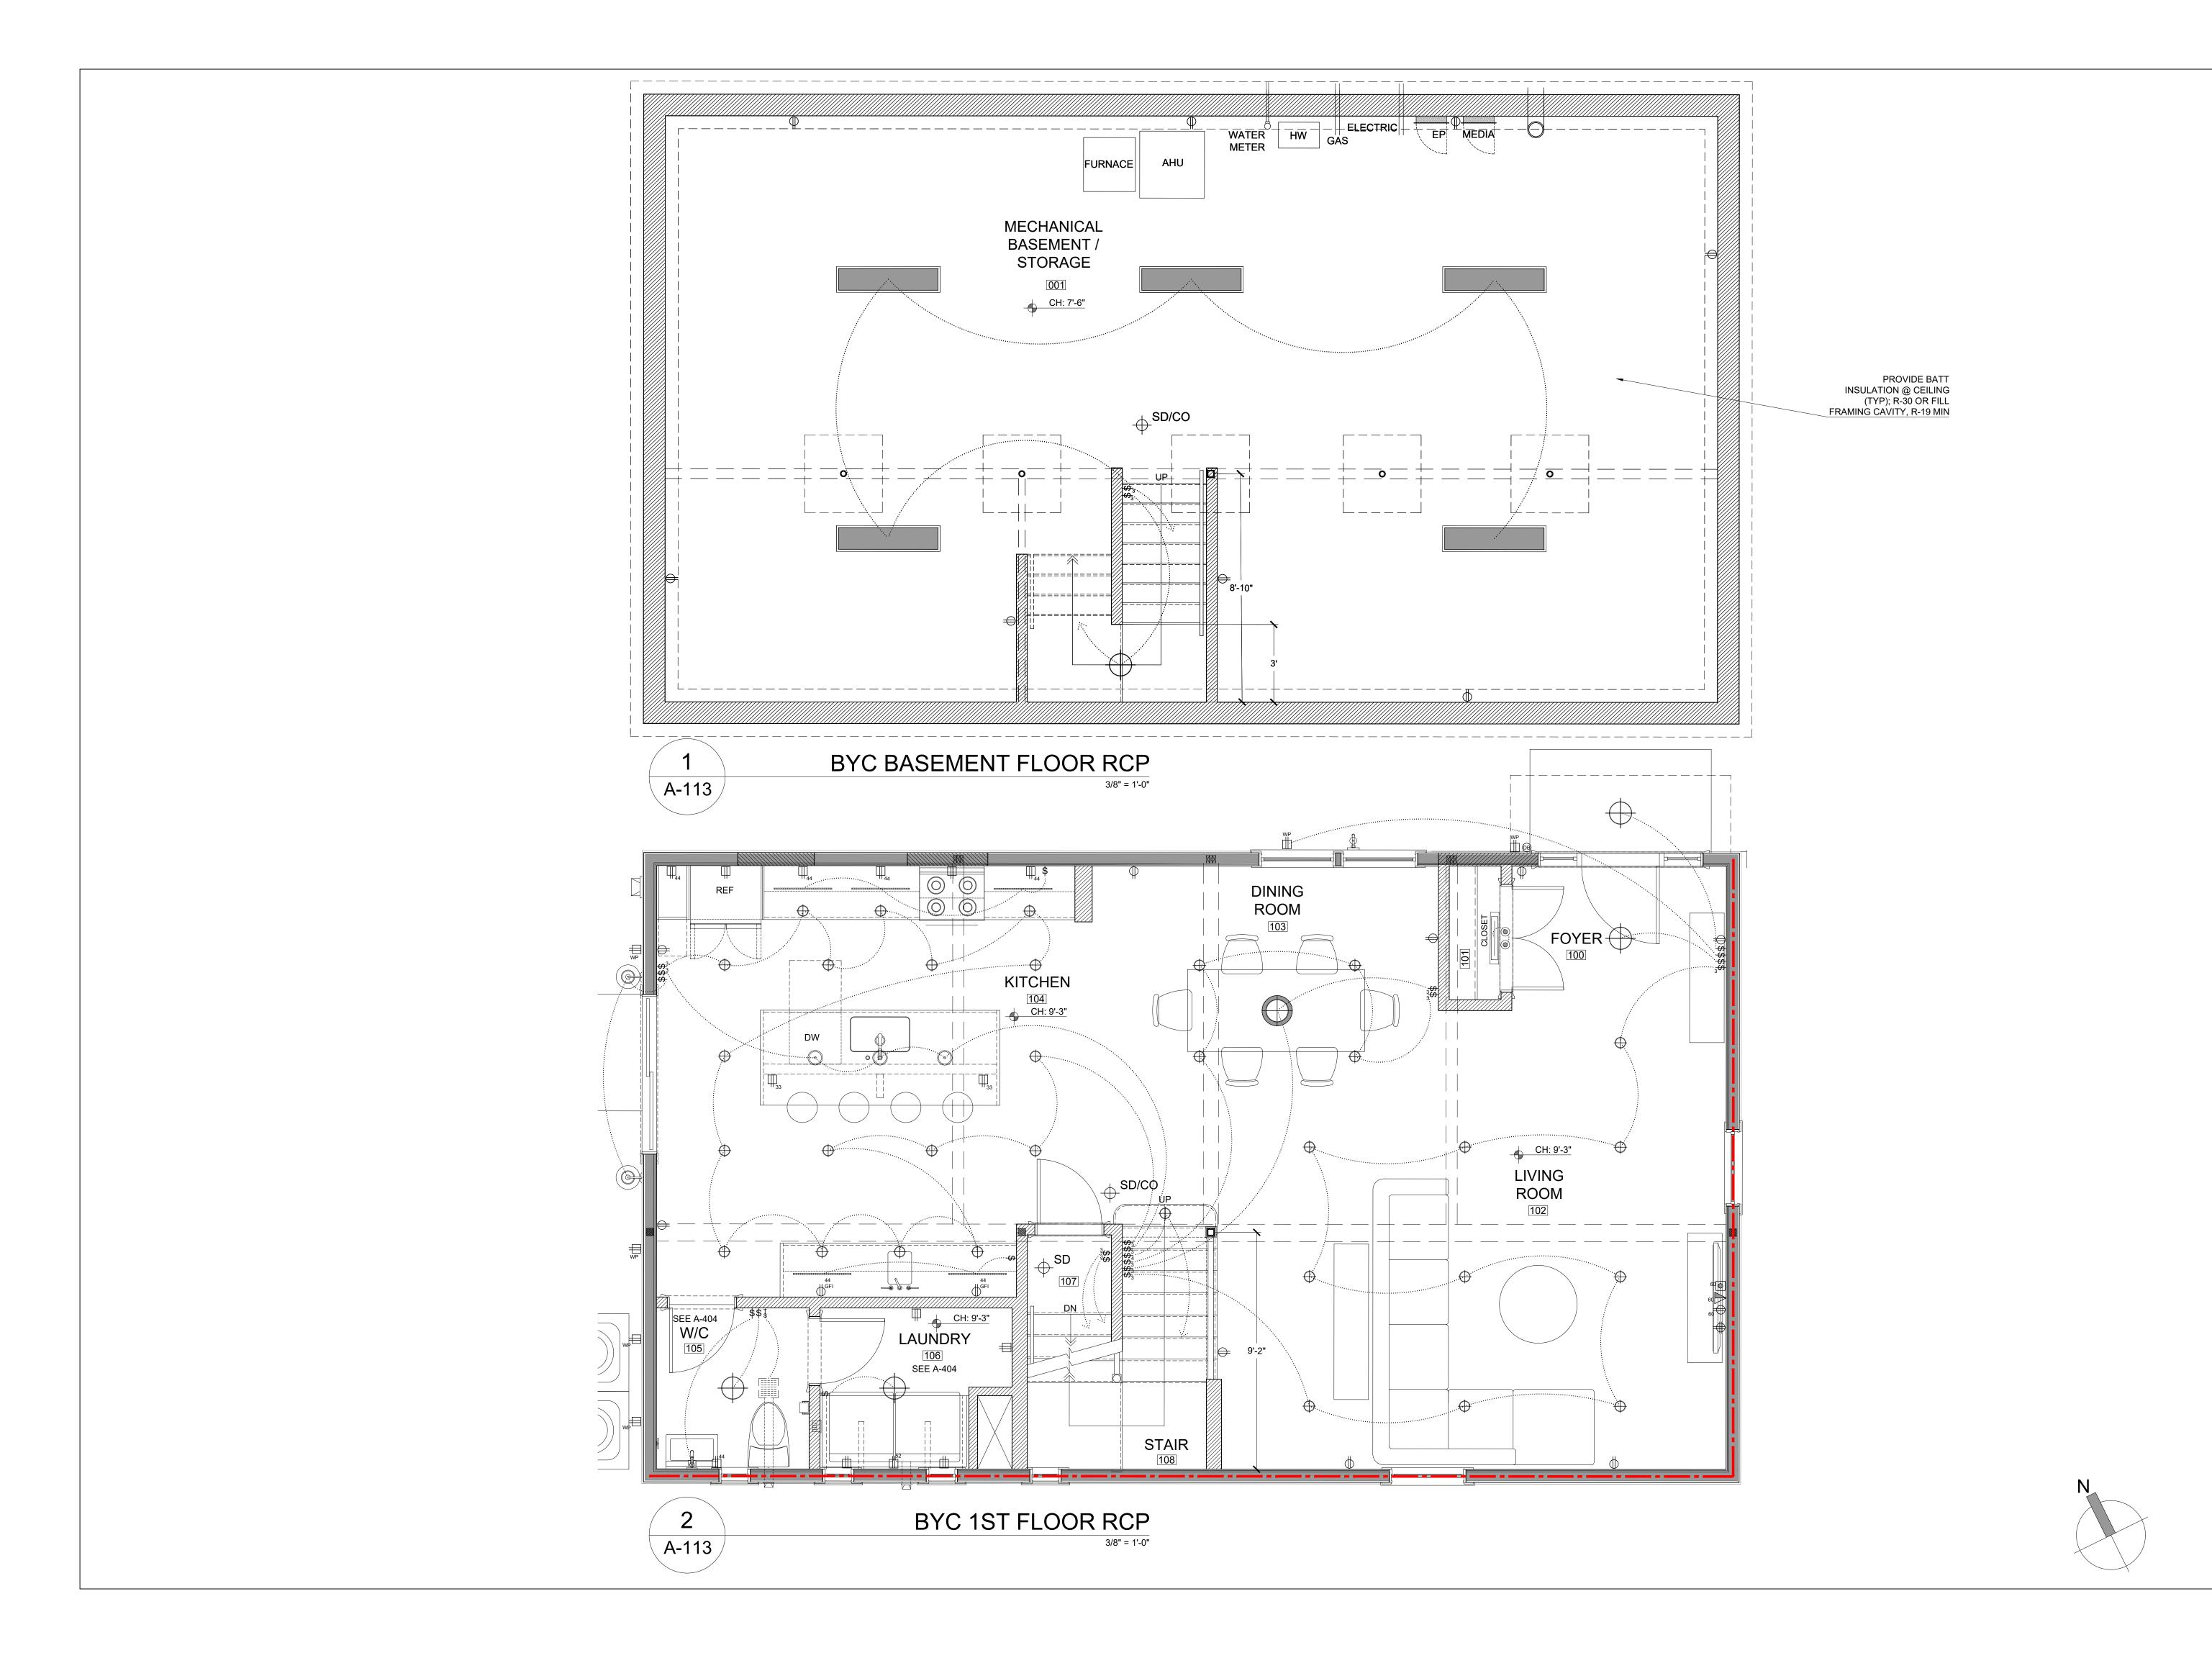




PROPOSED REFLECTED CEILING PLANS
PROPOSED RESIDENTIAL RENOVATION
ZEPEDA & JONG RESIDENCE
21-23 FRANCESCA AVE.
SOMERVILLE, MA 02144

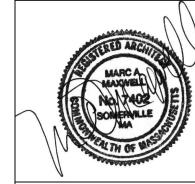

PROJECT NUMBER: 202037
DRAWING NUMBER:

A-113

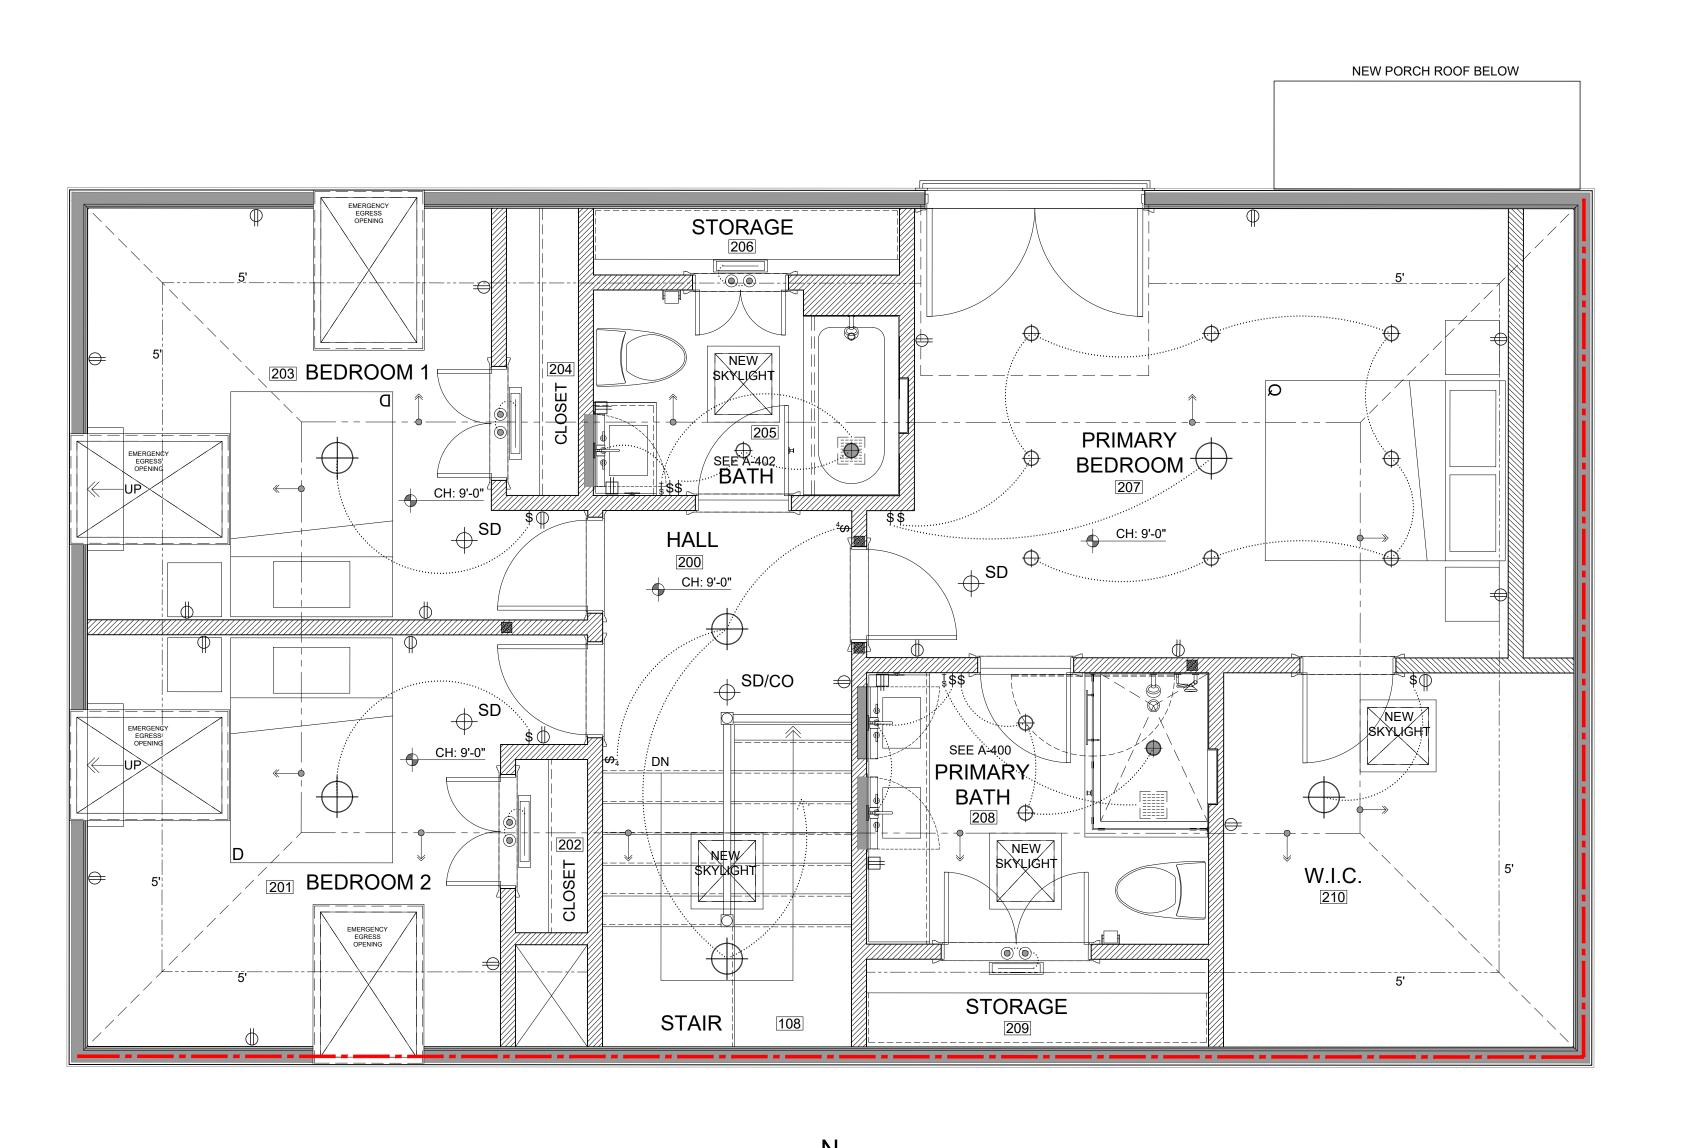

BYC 2ND FLOOR RCP

A-114

EMERGENCY EGRESS OPENINGS IF DOUBLE OR SINGLE HUNG:
- 3.3 SF MIN OPENING AREA
- 24" & 20" MIN OPENING DIMENSIONS
CAN BE IN EITHER DIRECTION
- 44" MAX SILL HEIGHT ANY OTHER APPROVED WINDOW TYPE:
-5.7 SF(5.0 SF IF BELOW GRADE) MIN
OPENING AREA
- 24" MIN OPENING HEIGHT
- 20" MIN OPENING WIDTH
- 44" MAX SILL HEIGHT SEE IRC 2015 SECTION R310 & MA AMENDMENTS FOR REQUIREMENTS EMERGENCY EGRESS WINDOW WELLS - 36" MIN WIDTH & PROJECTION
- 9 SF MIN FOOTPRINT
- LADDER/STEPS NOT REQUIRED IF WELL
HEIGHT IS LESS THAN 44"
- TIE INTO FOUNDATION DRAINAGE
SYSTEM OR APPROVED ALTERNATE
- 36" MIN HEAD HEIGHT ABOVE WELL SEE IRC 2015 SECTION R310 & MA AMENDMENTS FOR REQUIREMENTS


-MAX ALLOWABLE CEILING HEIGHT TO BE 12'-0" -ROOF RAFTERS TO INTERSECT THE WALL PLATE @ MAX 2'-0" AFF

MAXWELL A

PROPOSED REFLECTED CEILING PLANS PROPOSED RESIDENTIAL RENOVATION ZEPEDA & JONG RESIDENCE 21-23 FRANCESCA AVE. SOMERVILLE, MA 02144


PROJECT NUMBER: 202037 DRAWING NUMBER:

A-114

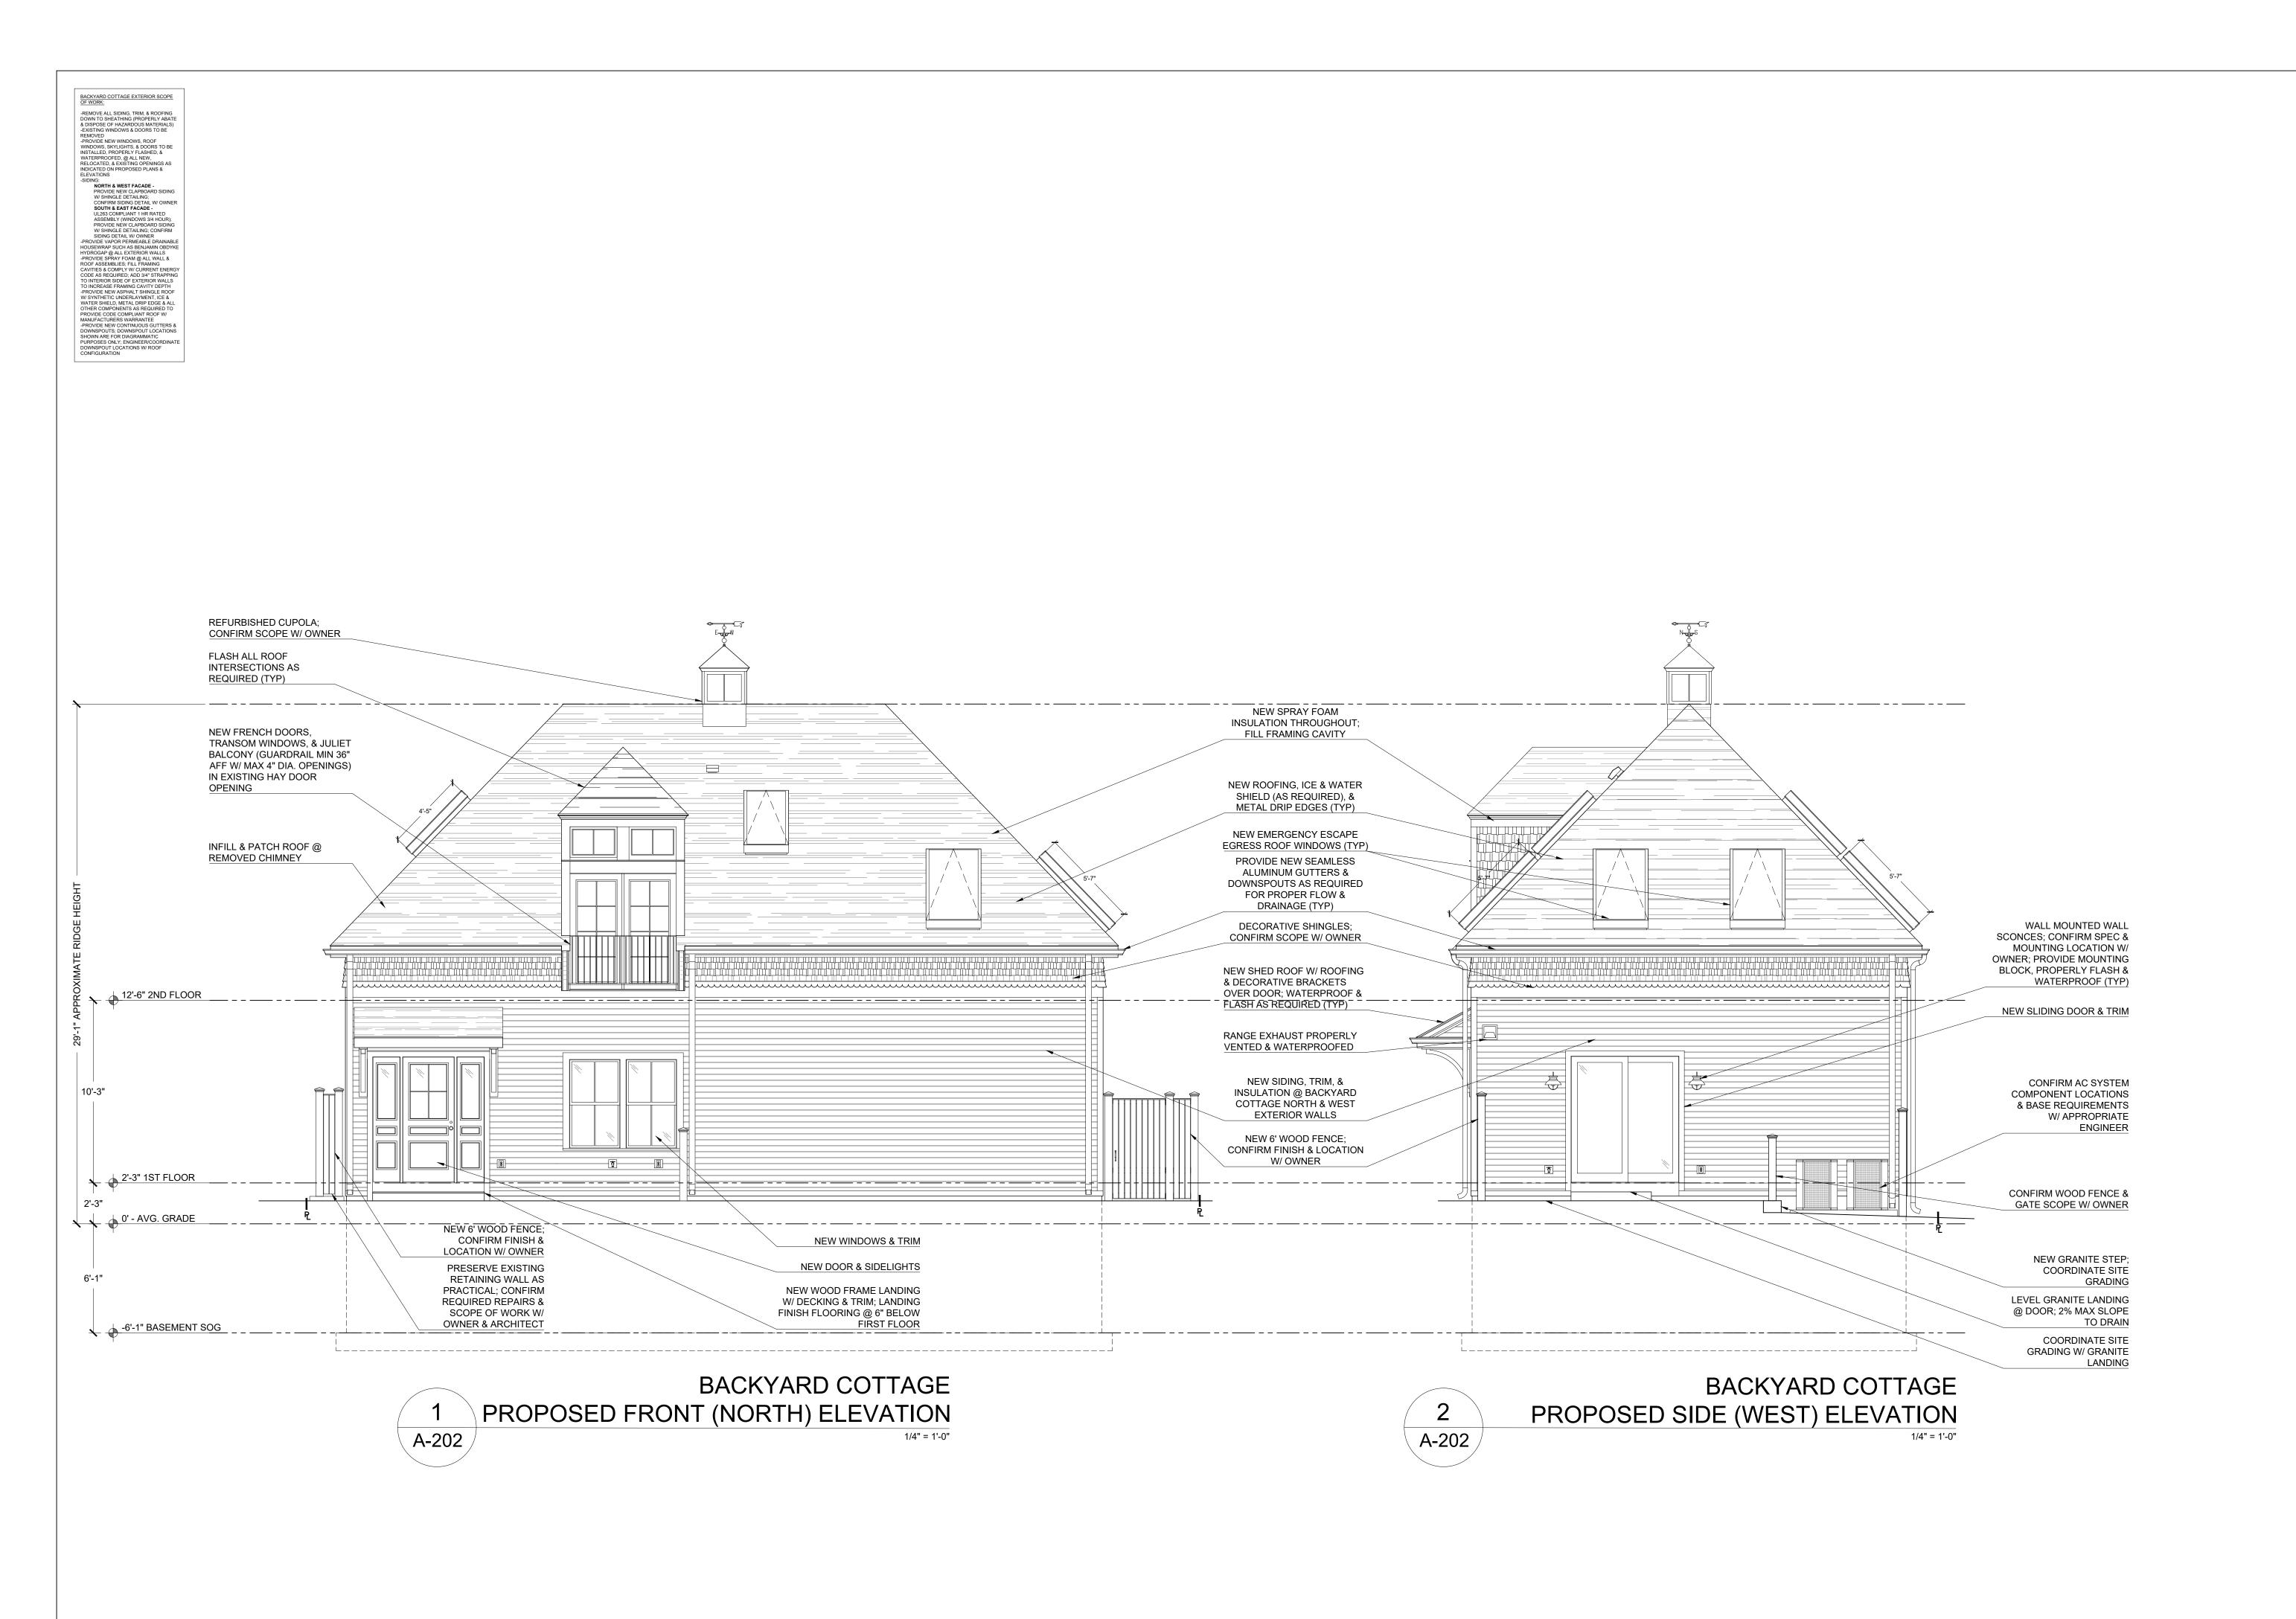

PROPOSED BACKYARD COTTAGE ELEVATIONS
PROPOSED RESIDENTIAL RENOVATION
ZEPEDA & JONG RESIDENCE
21-23 FRANCESCA AVE.
SOMERVILLE, MA 02144

MAXWELL PLANNING / PR

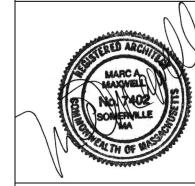

PROJECT NUMBER: 202037
DRAWING NUMBER:

A-202

scale: 1/4"=1'-0"
DATE: 12.23.2022





PROPOSED BACKYARD COTTAGE ELEVATIONS
PROPOSED RESIDENTIAL RENOVATION
ZEPEDA & JONG RESIDENCE
21-23 FRANCESCA AVE.
SOMERVILLE, MA 02144

PROJECT NUMBER: 202037

A-203

DRAWING NUMBER:

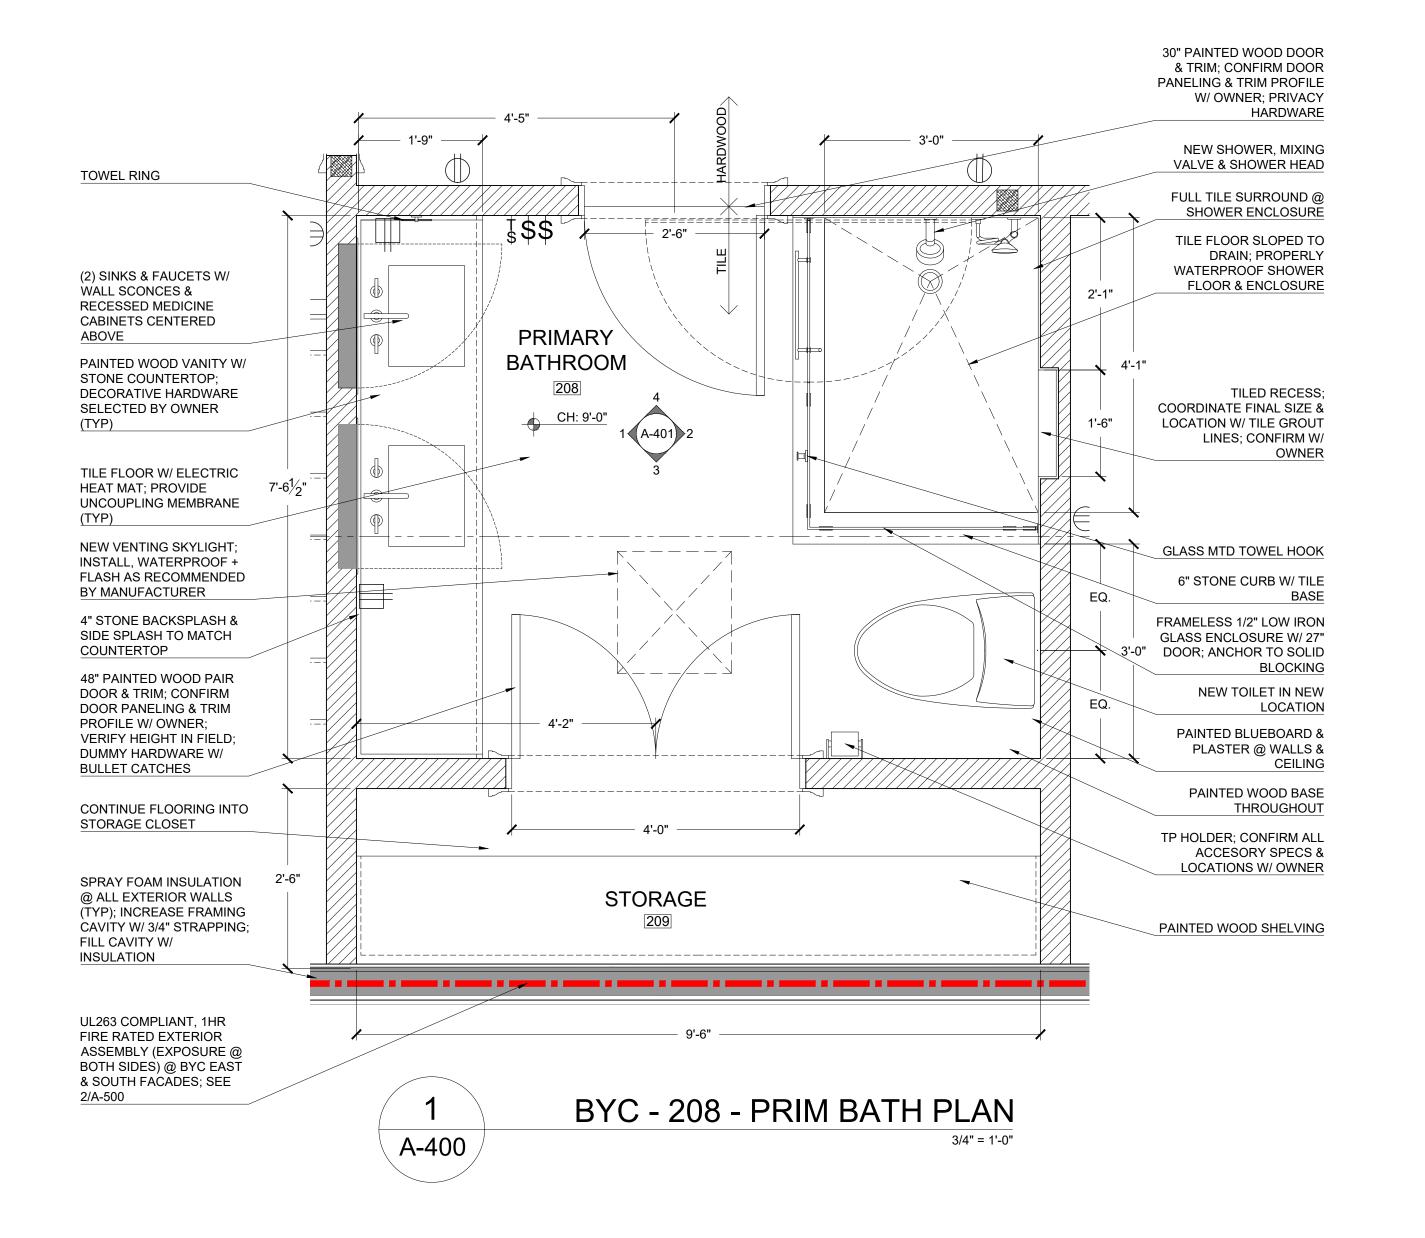


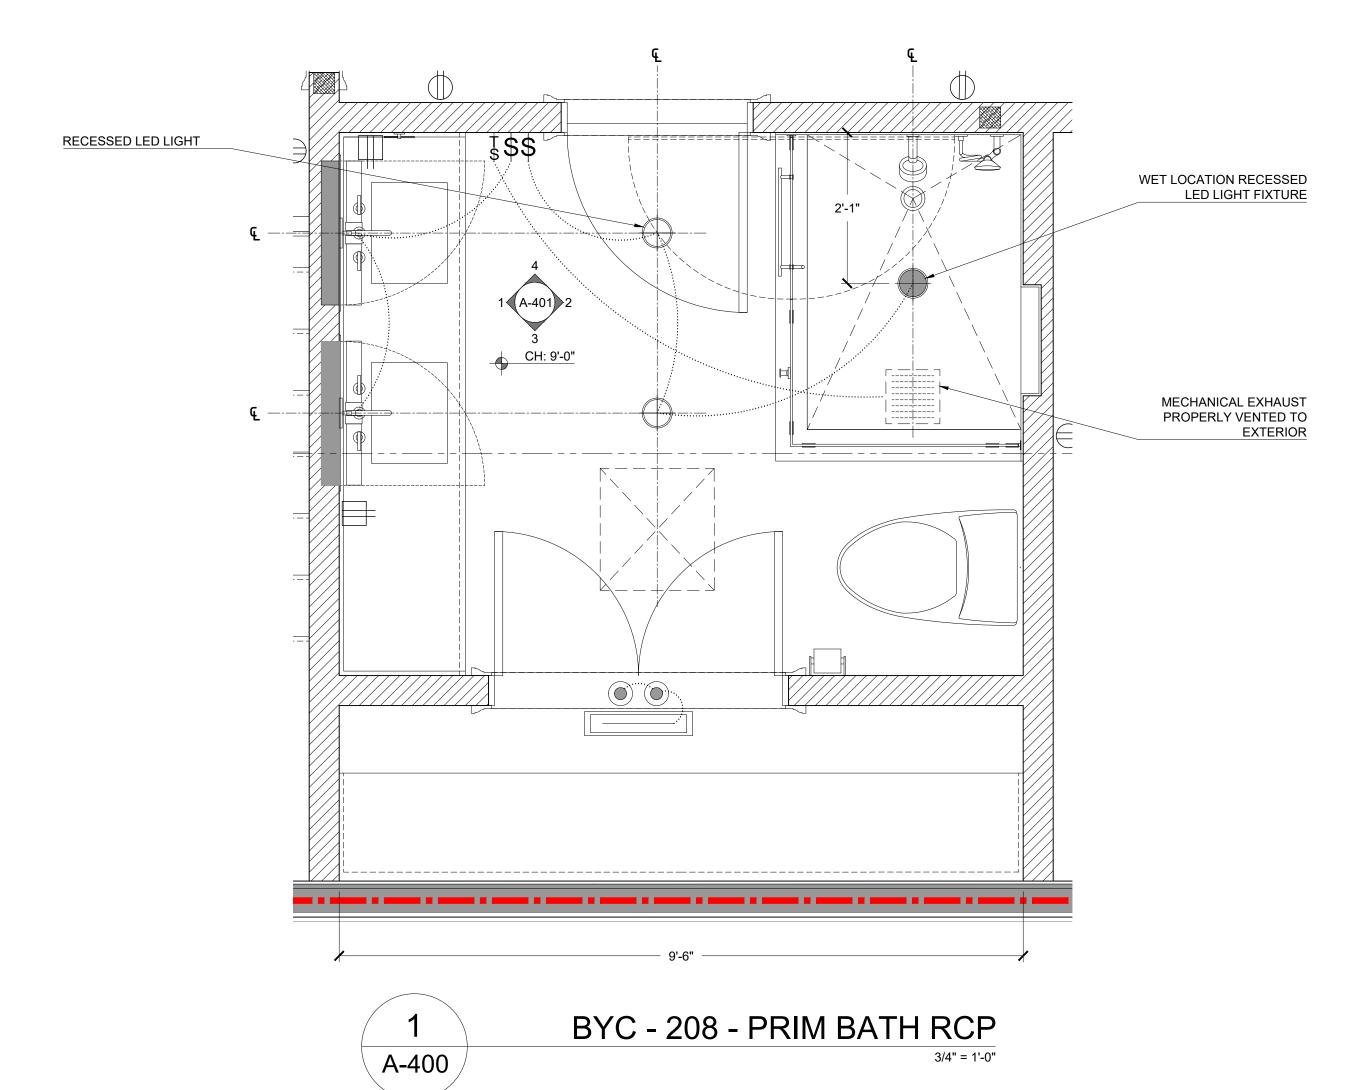



PROPOSED BYC - 208 - PRIM BATH FLOOR
PROPOSED RESIDENTIAL RENOVATION
ZEPEDA & JONG RESIDENCE
21-23 FRANCESCA AVE.
SOMERVILLE, MA 02144

PROJECT NUMBER: 202037 DRAWING NUMBER:


A-400

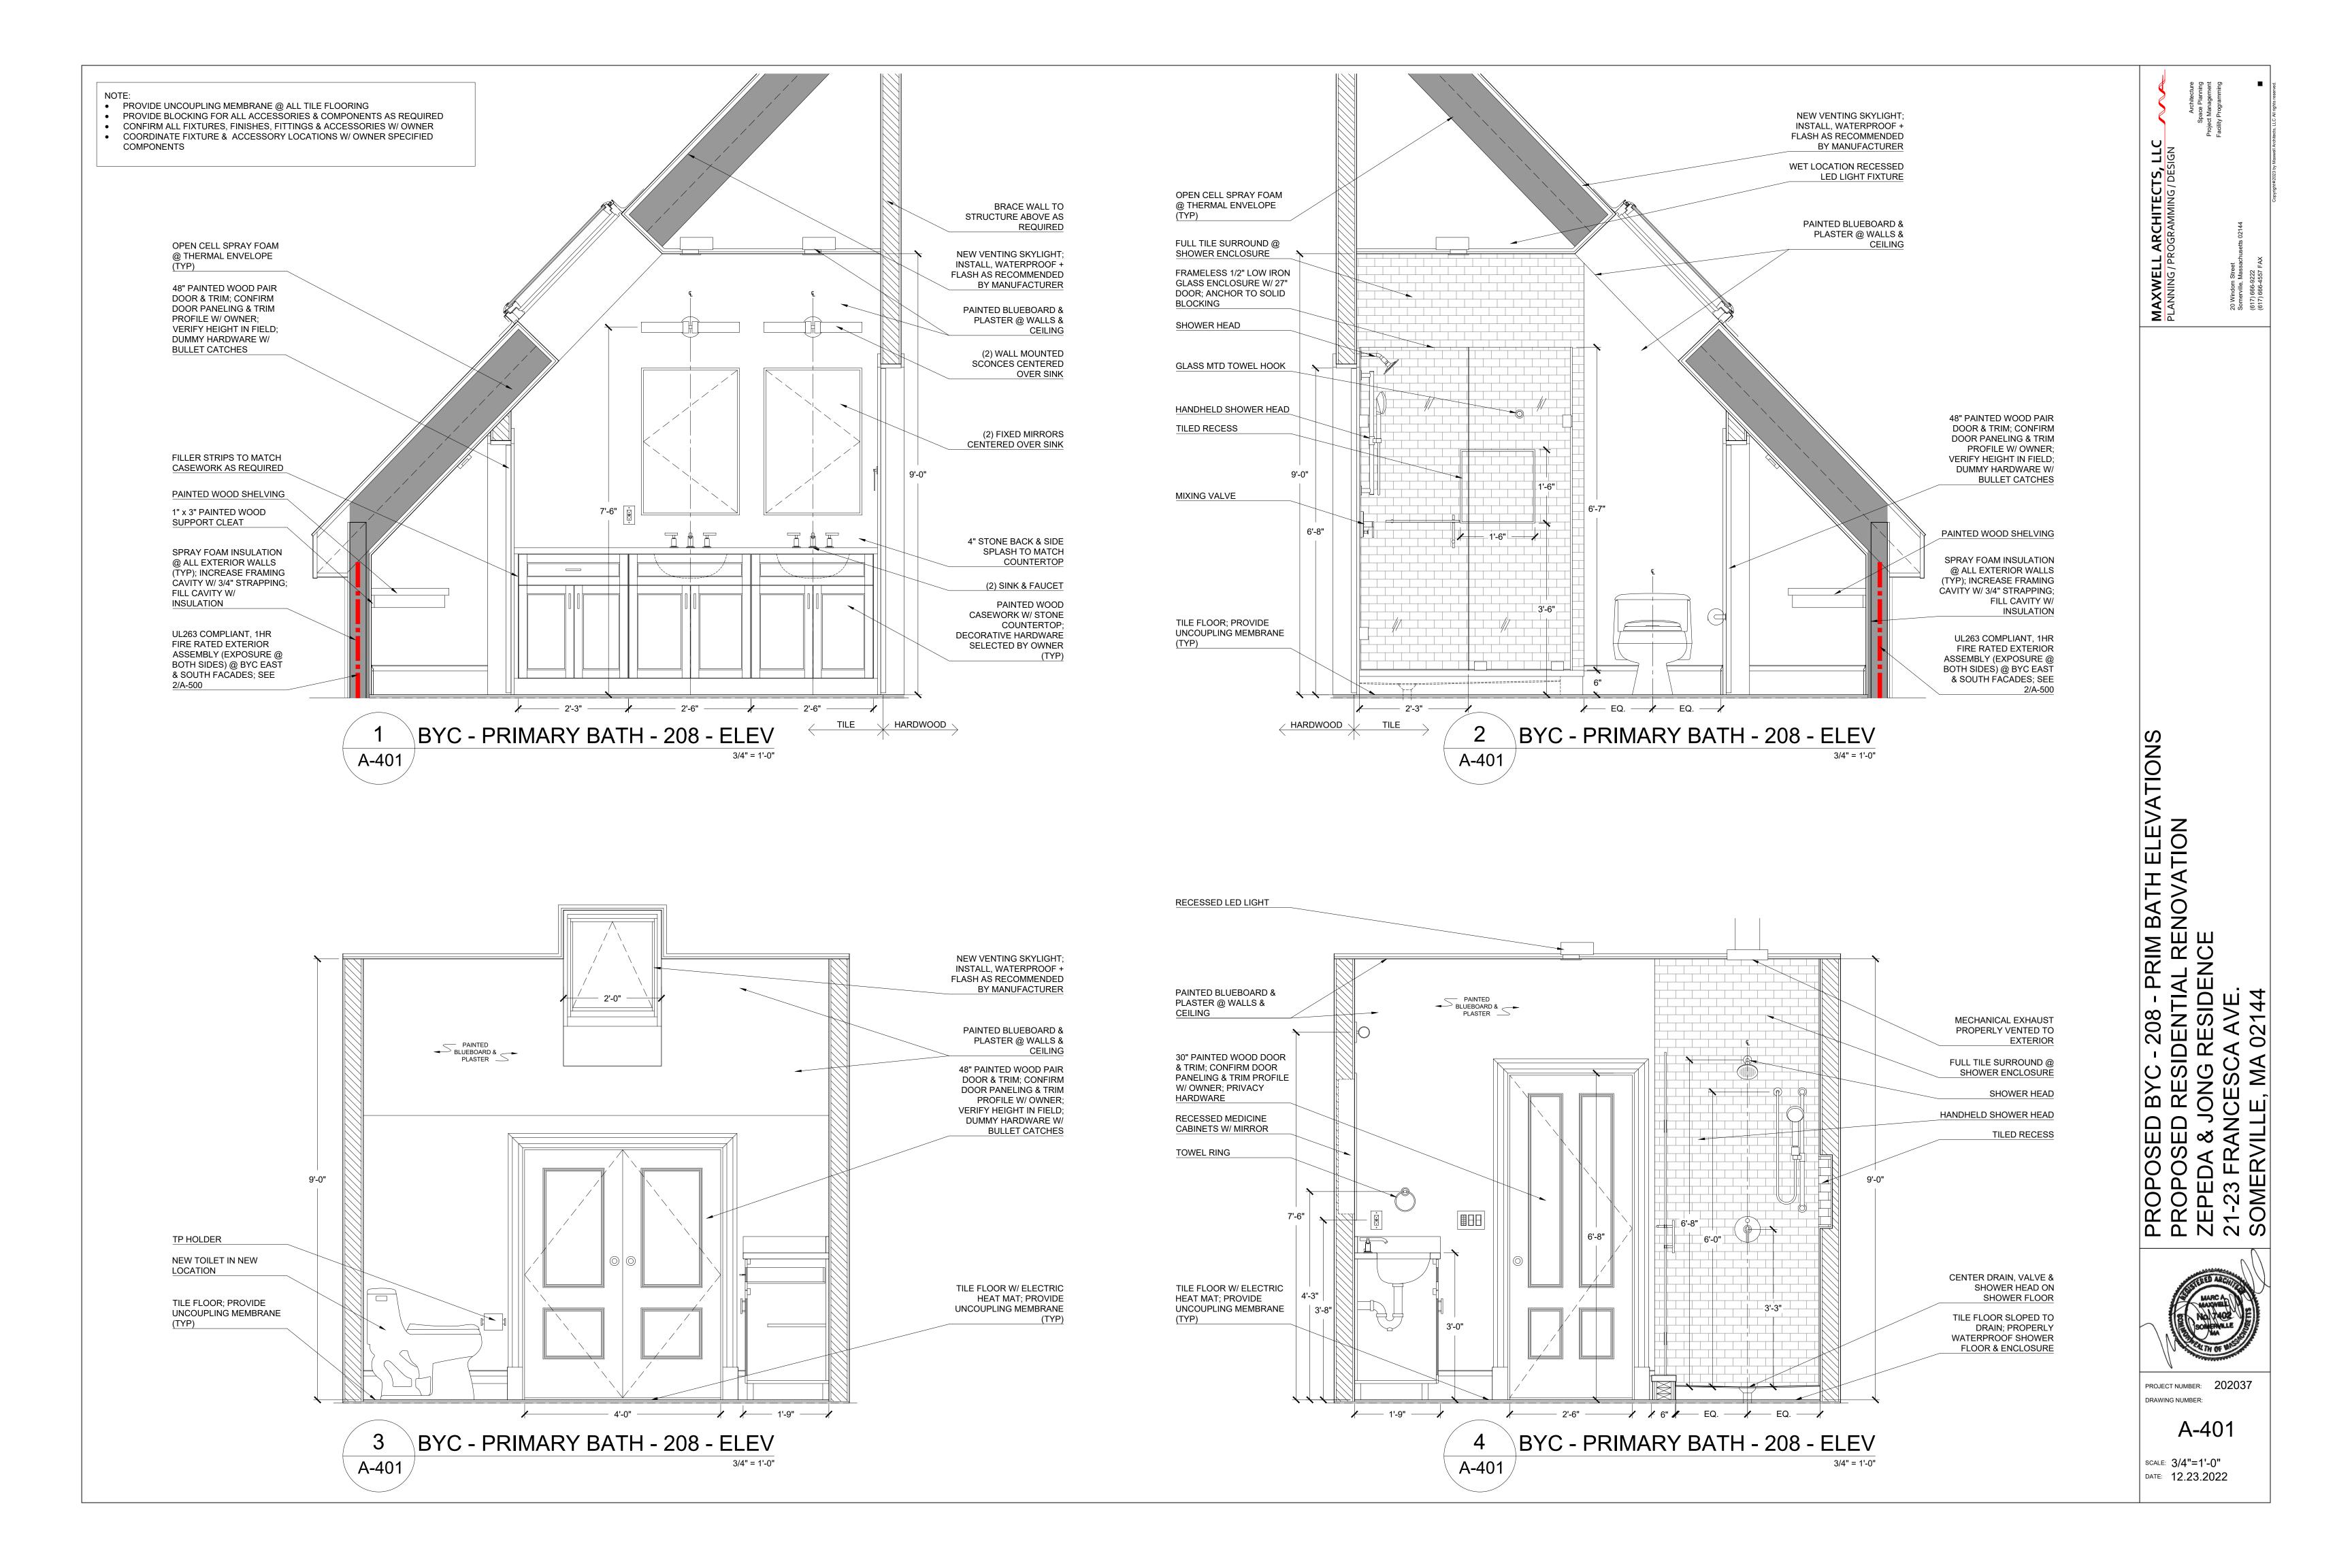

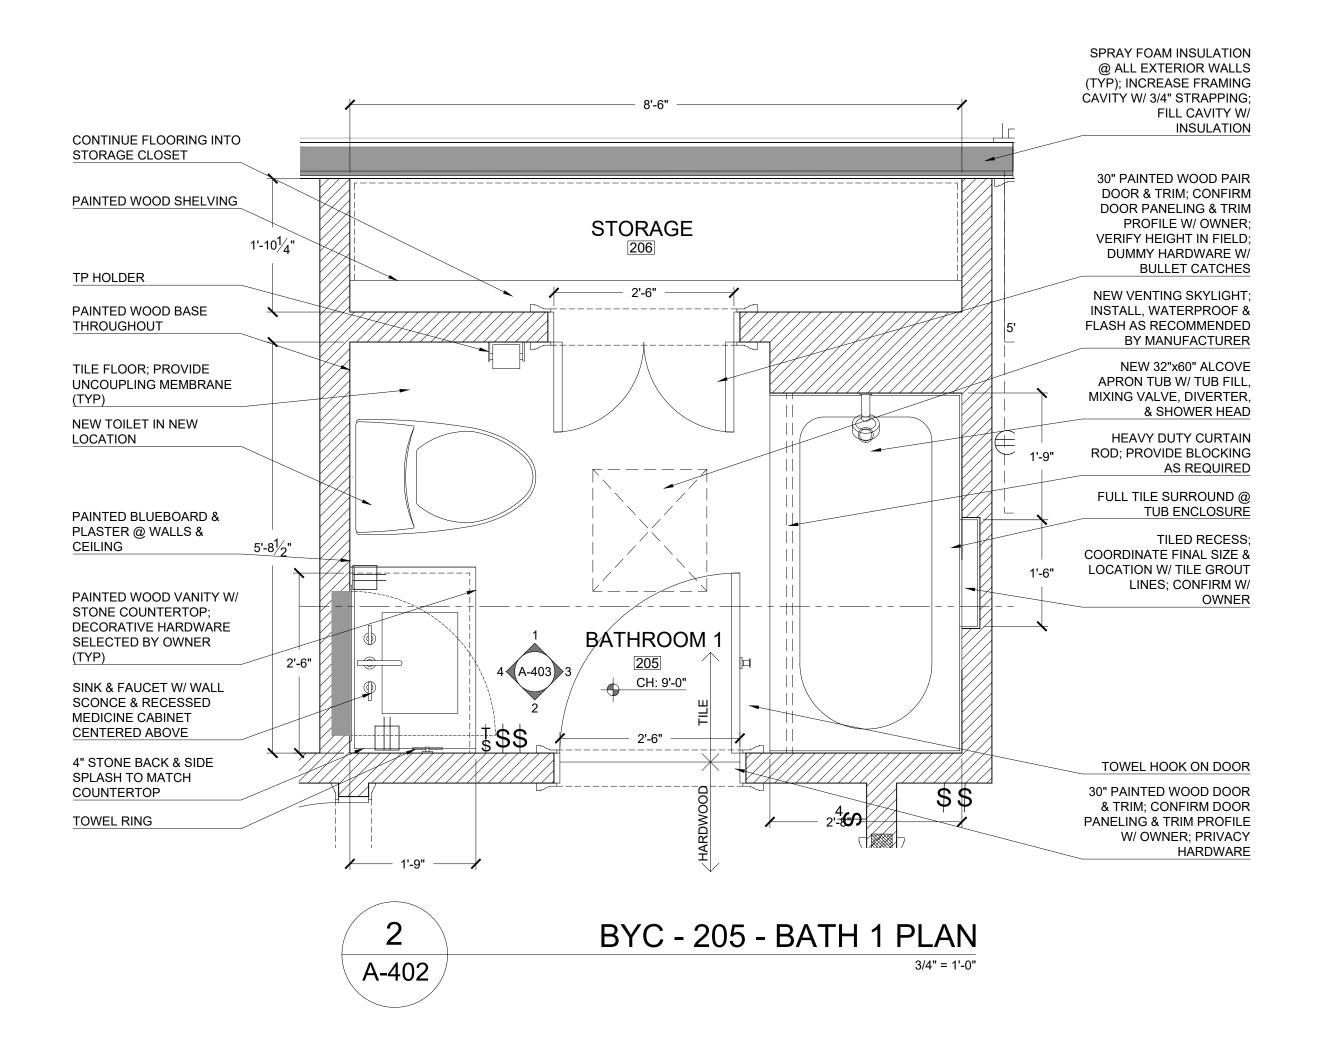

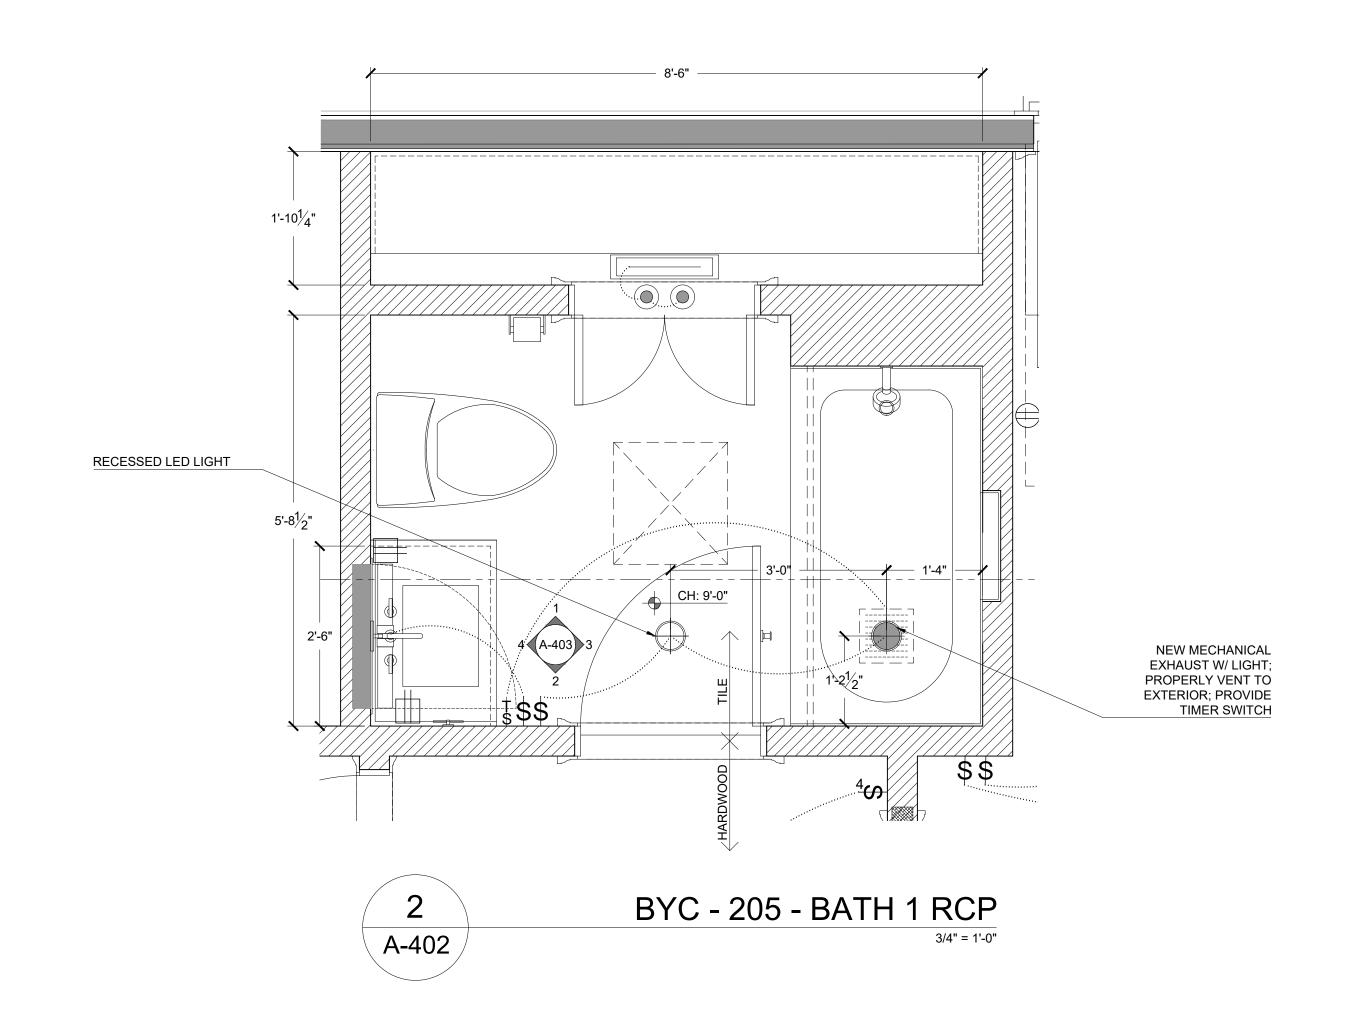




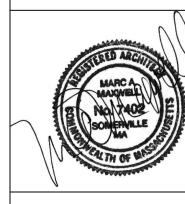

PROJECT NUMBER: 202037
DRAWING NUMBER:

A-402

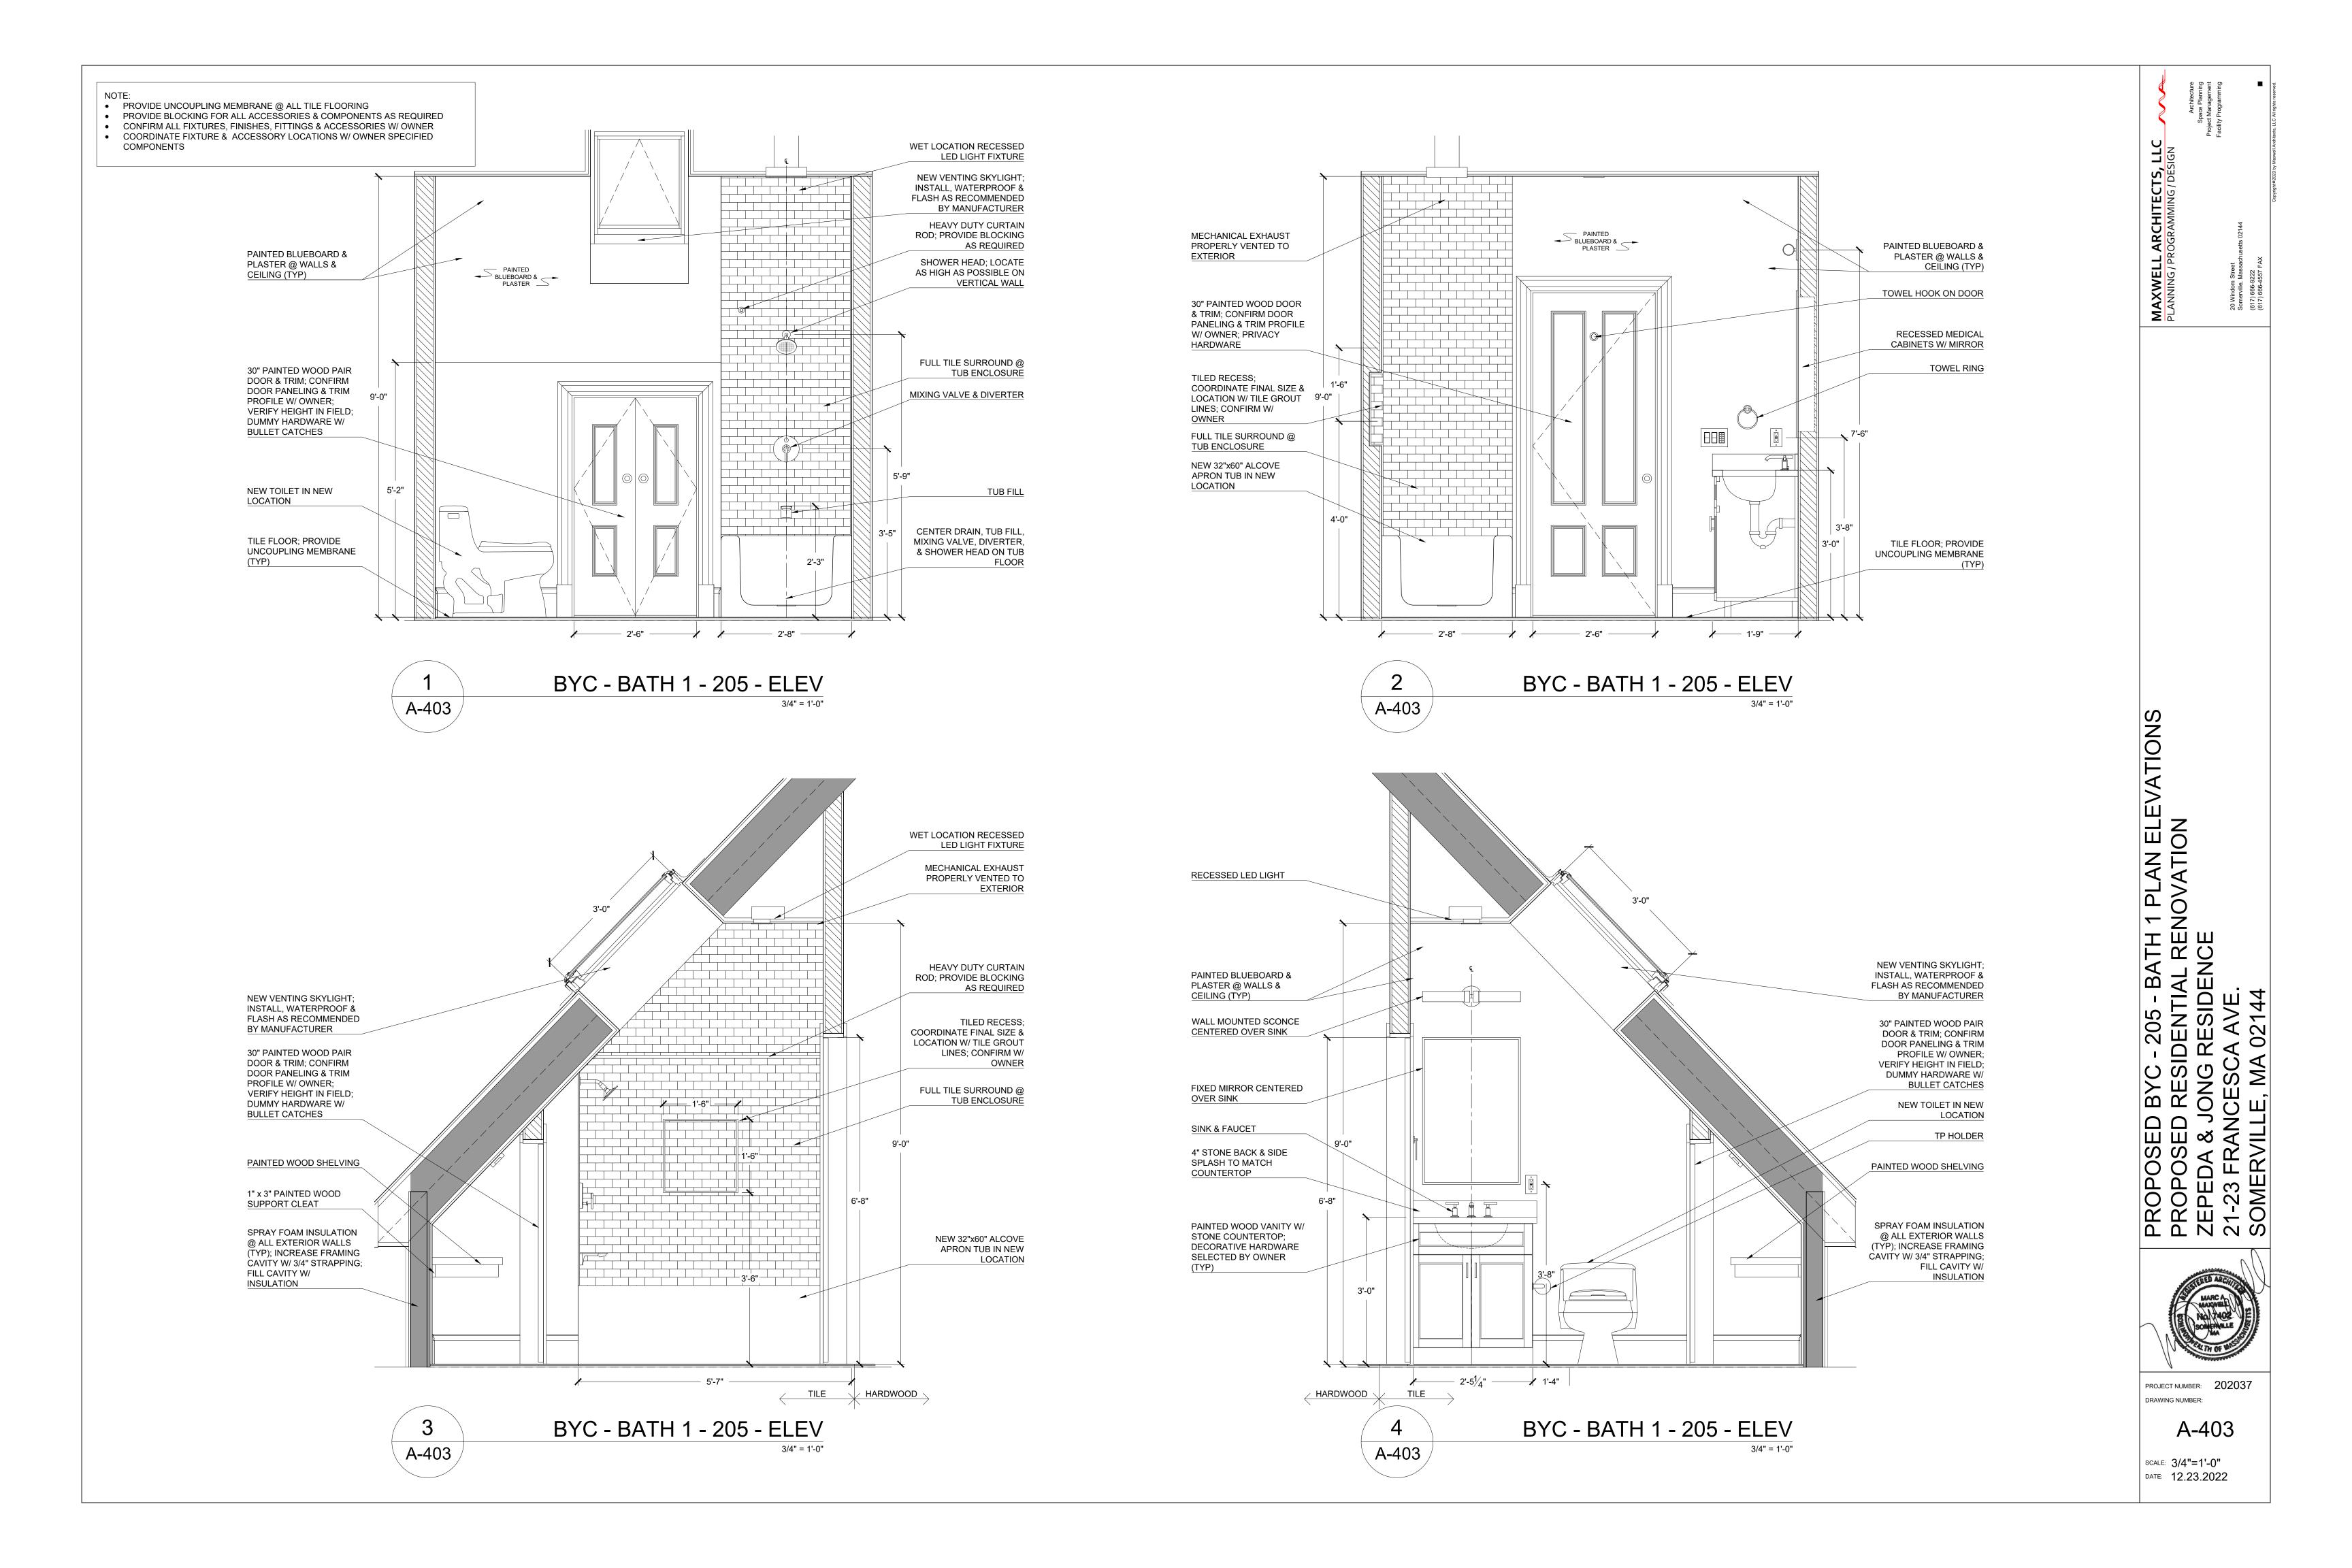


COMPONENTS


 CONFIRM ALL FIXTURES, FINISHES, FITTINGS & ACCESSORIES W/ OWNER COORDINATE FIXTURE & ACCESSORY LOCATIONS W/ OWNER SPECIFIED


106 FLOOR PROPOSED BYC - W/C 1 105 / LAUNDRY 10
PROPOSED RESIDENTIAL RENOVATION
ZEPEDA & JONG RESIDENCE
21-23 FRANCESCA AVE.
SOMERVILLE, MA 02144


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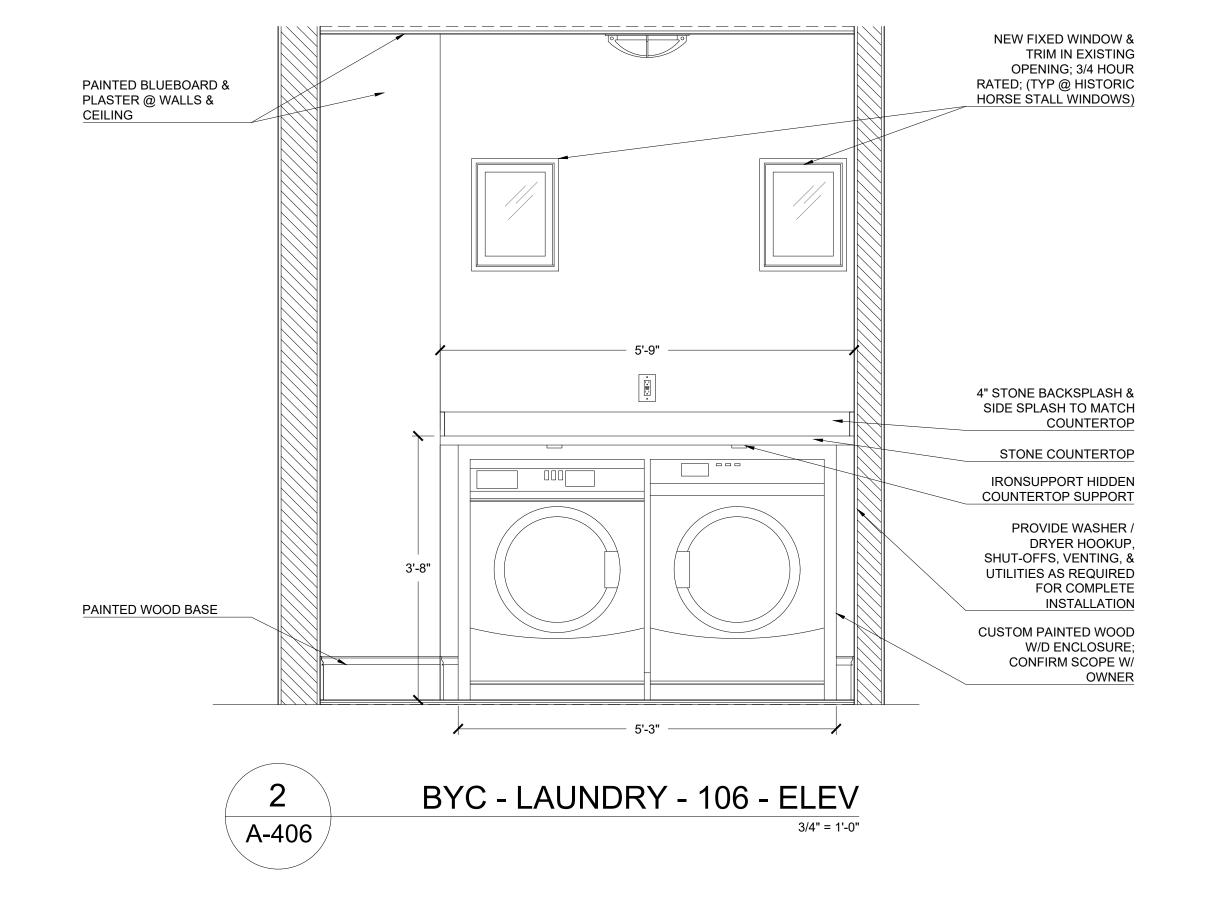
A-404



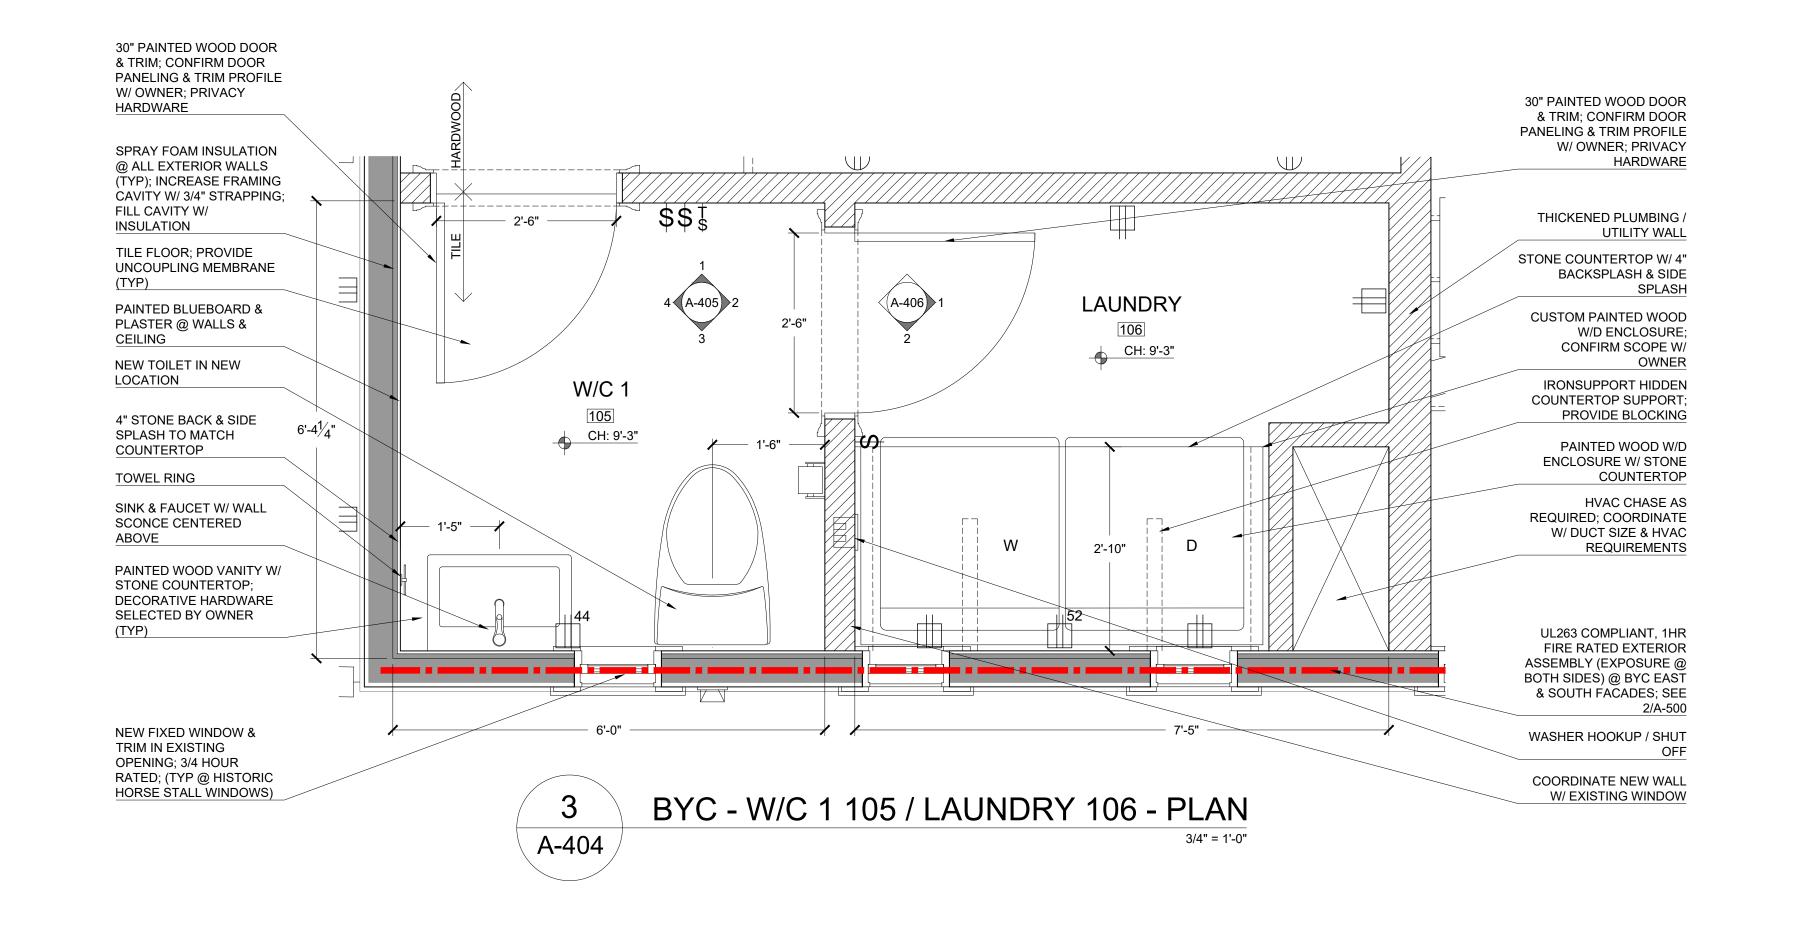

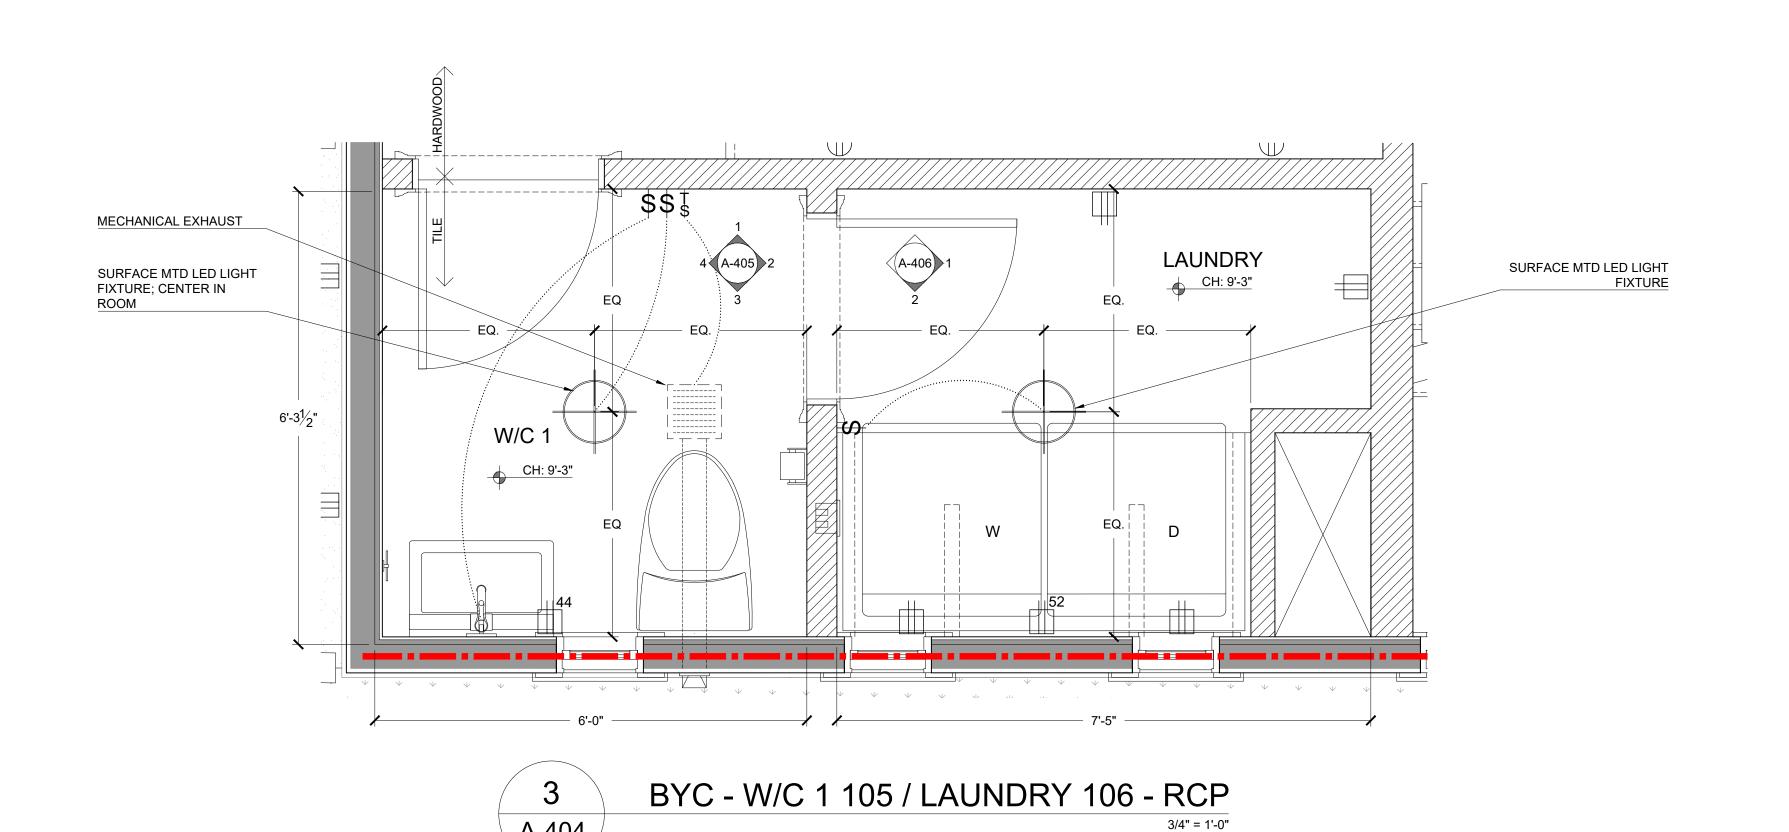

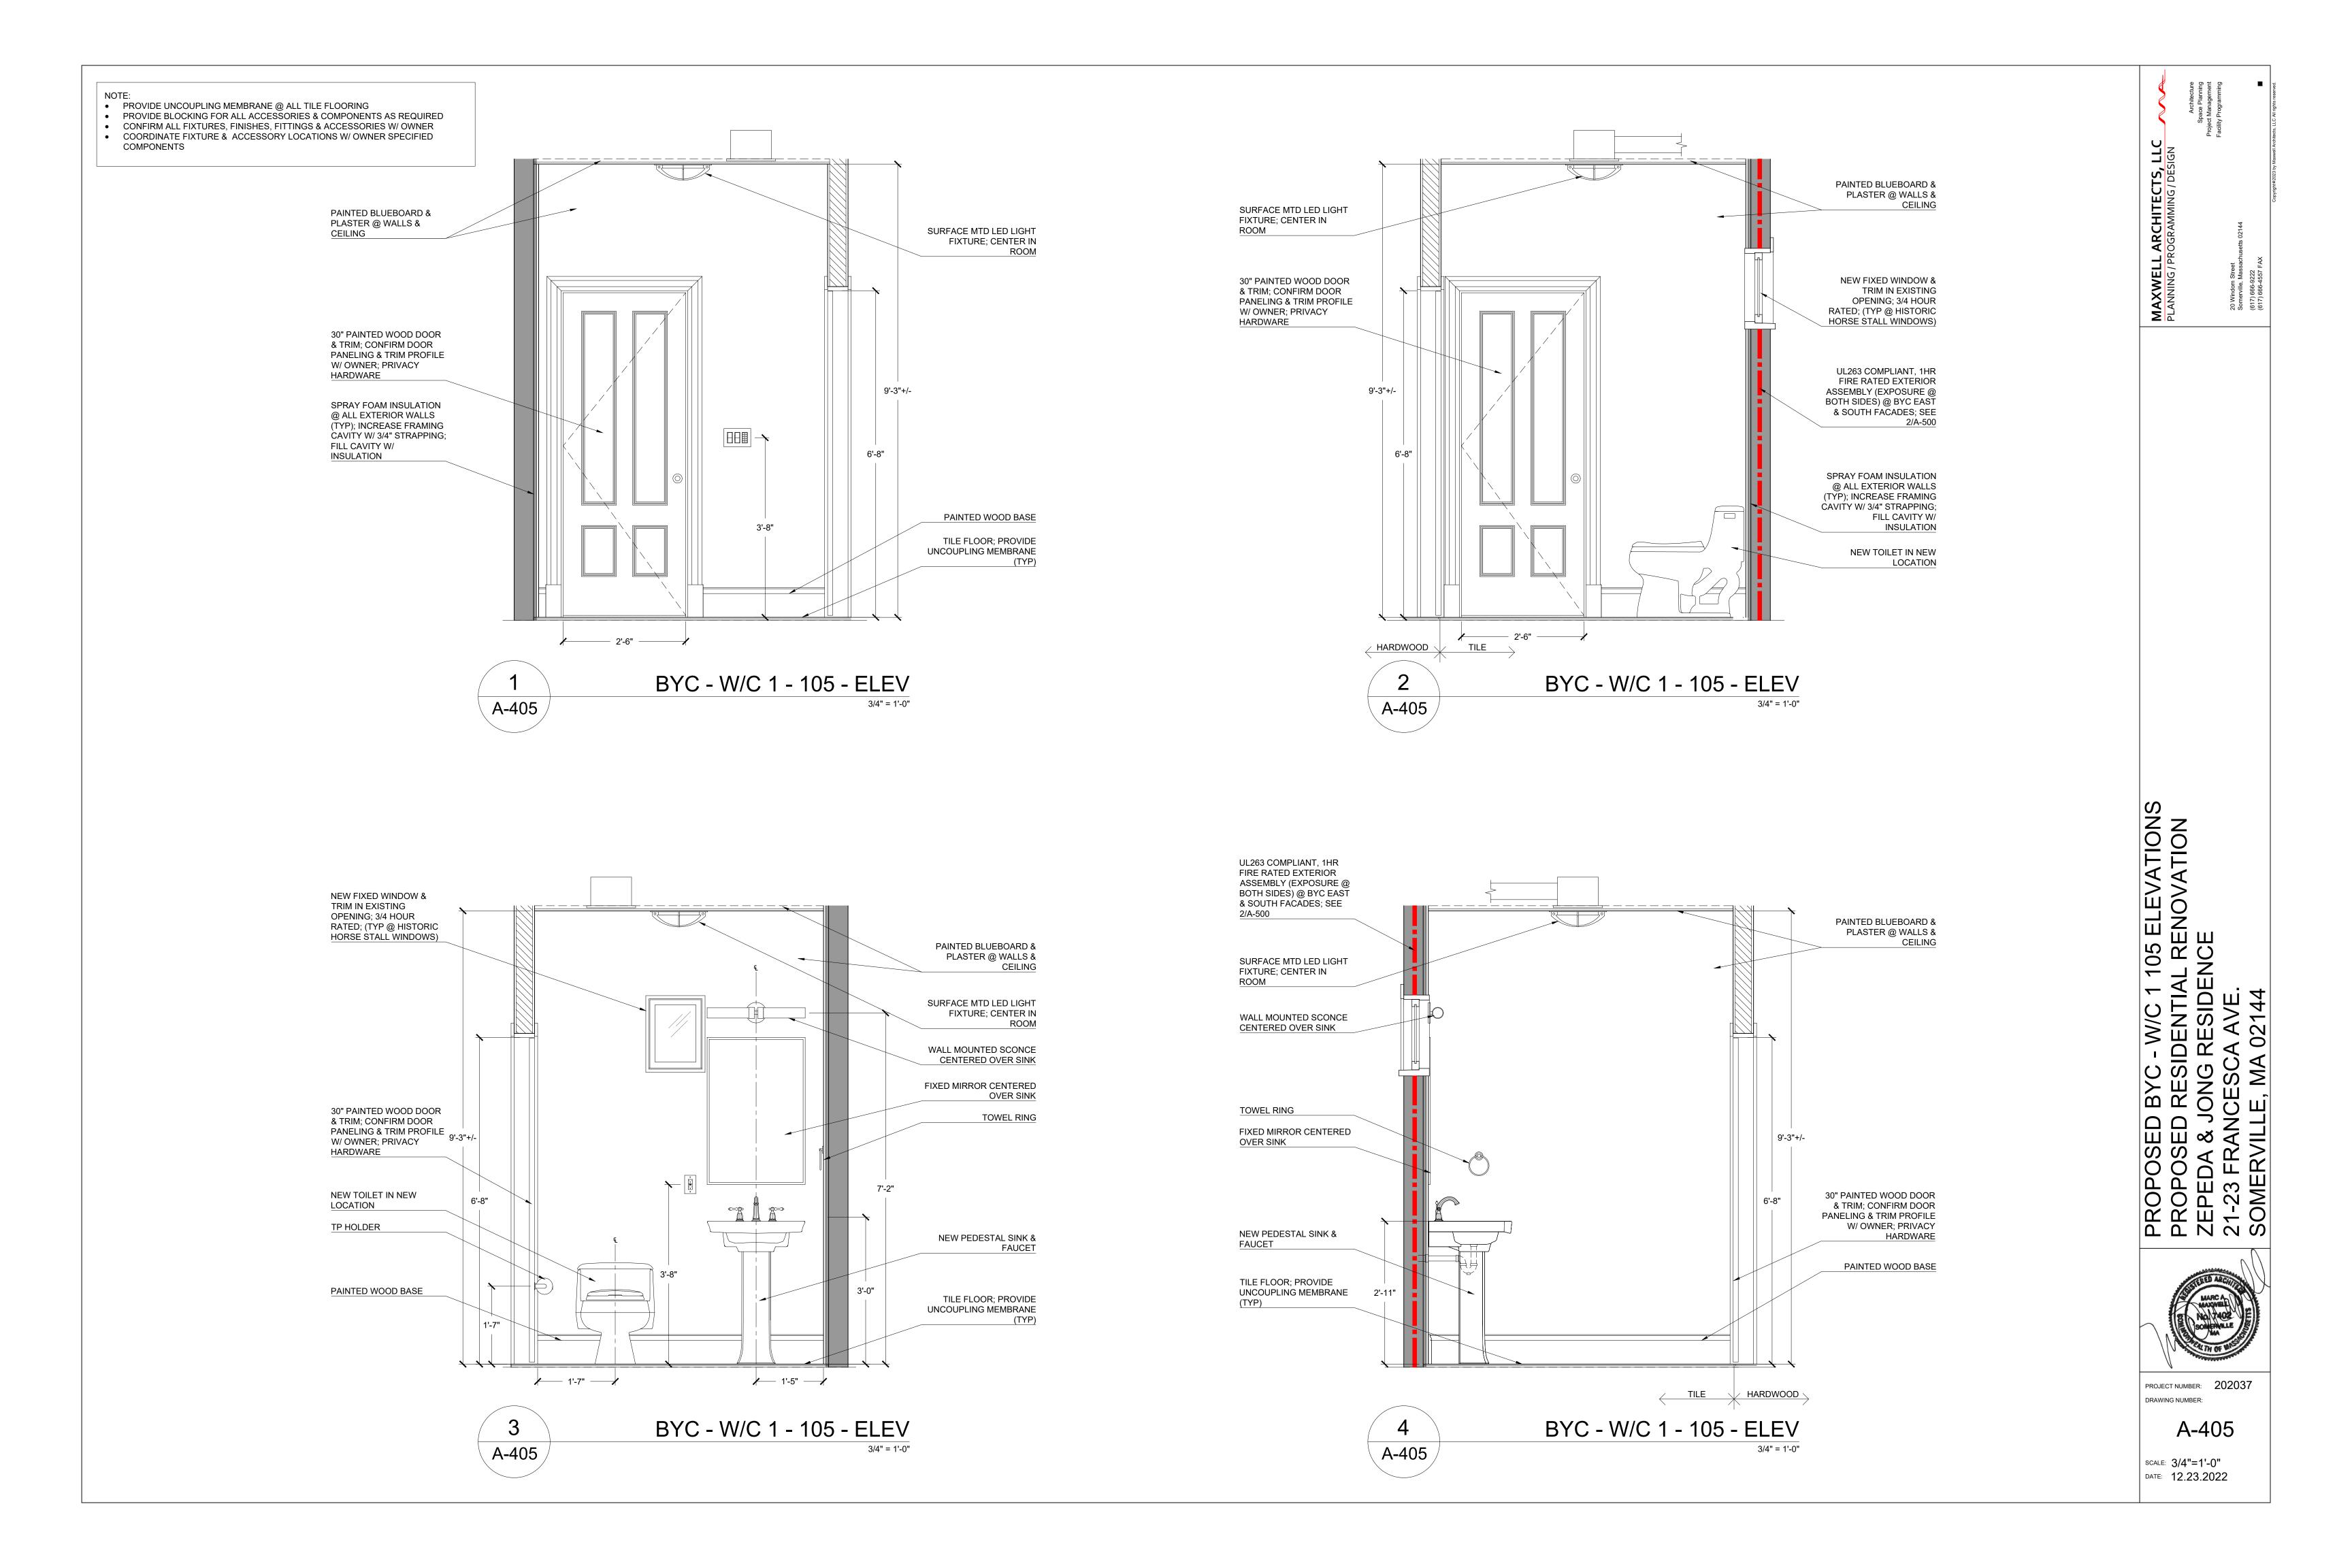

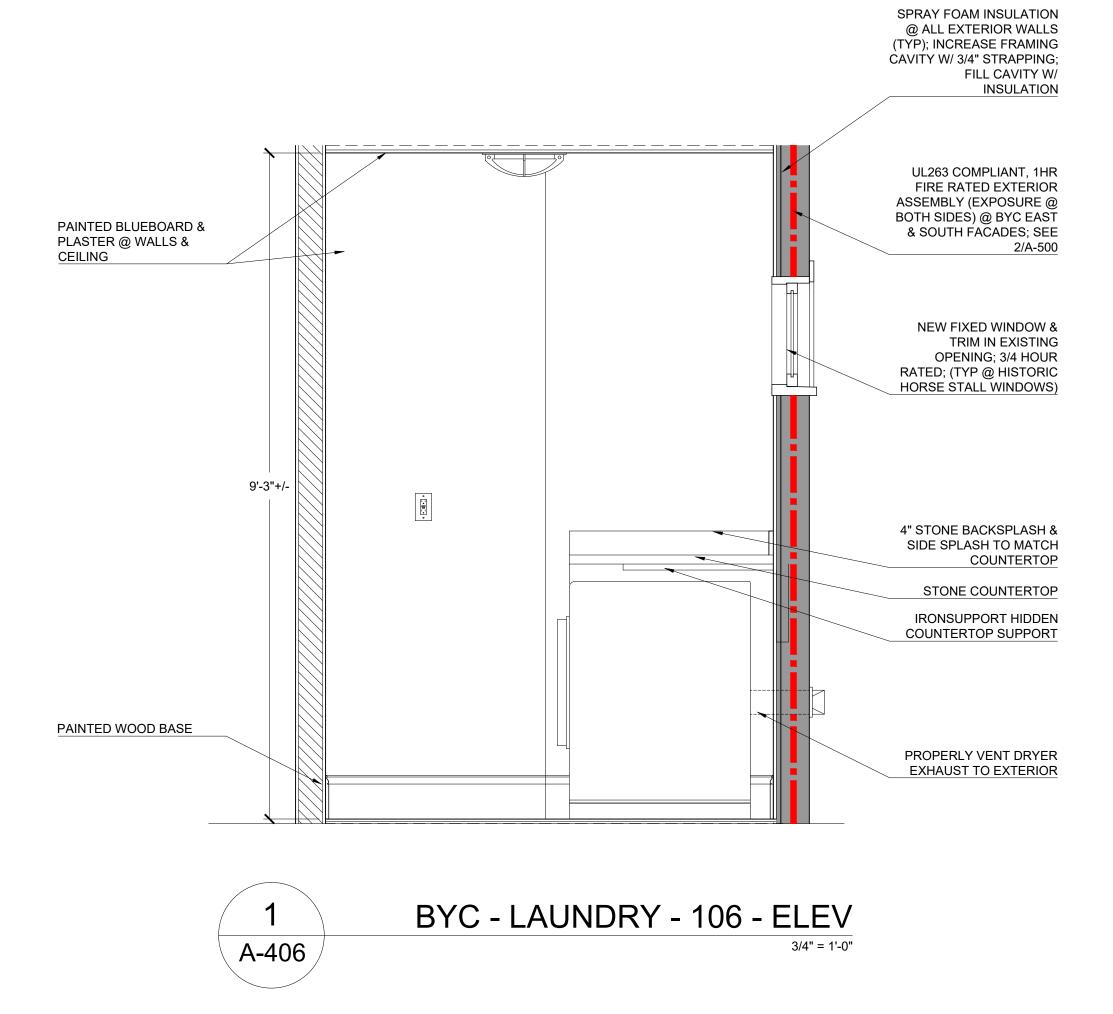







PROJECT NUMBER: 202037
DRAWING NUMBER:

A-406

Adam Dash & Associates


Operating Account 48 Grove Street, Suite 304 Somerville, MA 02144 617-625-7373


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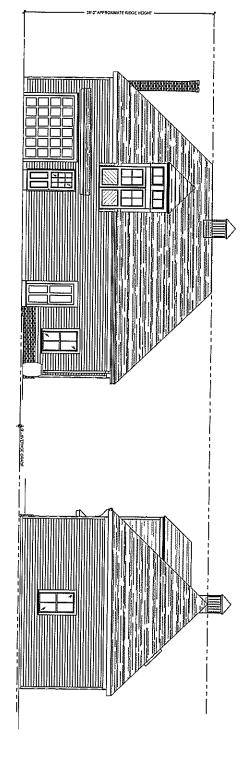
#006788# #211070175# 1310384999 Zone: NR

Existing Carriage House/Barn			
3.1.12 Backyard Cottage	8		
	Required	Provided	
Lot Dimensions			- 1
Lot Width (front driveway access)	34 ft	50 ft (existing)	conforming
Lot Depth	80 ft	101.52 ft (existing)	conforming
Lot Development			
Lot Coverage (maximum)	60%	49%	conforming
Green Score	0.35 minimum	0.38	conforming
Building Setbacks			
Primary Front Setback (min/max)	60 ft (min)	74'-9" (existing)	conforming
Side Setbacks	3 ft	1'-10" east	existing non-conforming
	3 ft	5'-7" west	conforming
Rear Setback (min) Main House	3 ft	1'-8"	existing non-conforming
Building Separation (min)	Section 2		
Main house to Carriage House	10 ft	15'-6"	conforming
Carriage House to 17-19 Garage	10 ft	7'-1"	existing non-conforming
Main Massing			
Width (max)	24 ft	42'-5"	existing non-conforming
Depth (max)	32 ft	24'-5"	conforming
Floor Plate (max)	576 sf	975 sf (existing)	existing non-conforming
Story Height (max)	12 ft	10'-9" (existing)	conforming
Number of Stories (max)	1.5	1.5	conforming
Roof Type	Flat, Gable	Gable/Hip with Cupola	conforming
Façade Composition			7
Ground Story Fenestration Residential Use (min/max)	15%- 50%	19%	conforming
Ground Story Fenestration Vehicular Parking (min/max)	0%- 50%	0%	conforming
Upper Story Fenestration (min/max)	15%-50%	NA NA	
Use & Occupancy			
Dwelling Units per Lot (max)	3	2	conforming
Dwelling Units (max)	1	1	conforming



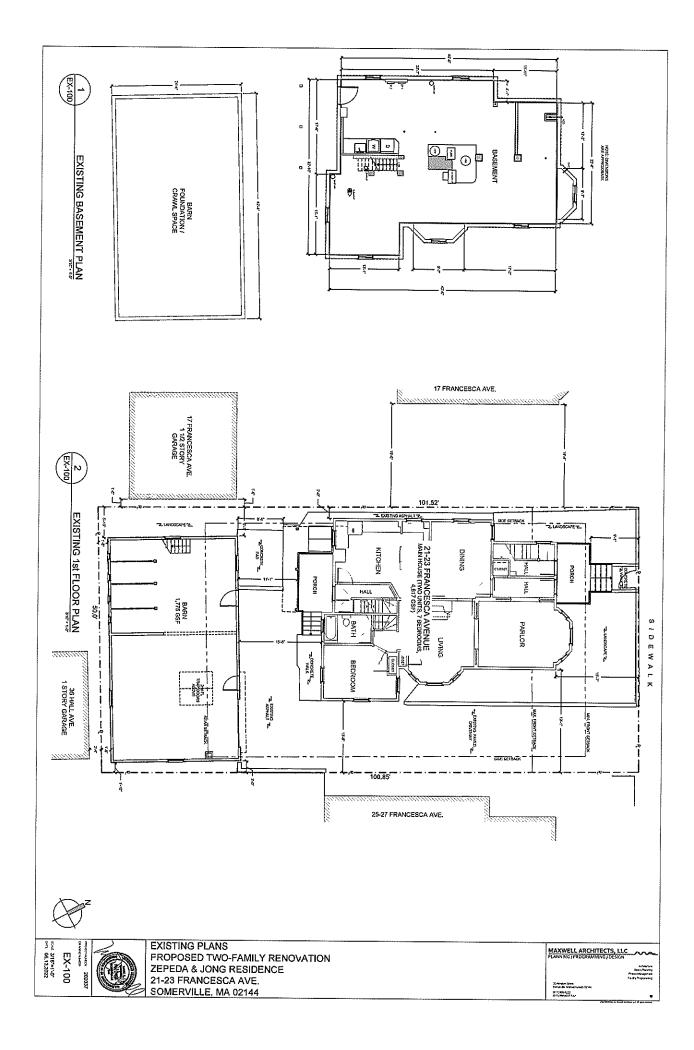

BACKYARD COTTAGE
EXISTING FRONT (NORTH) ELEVATION

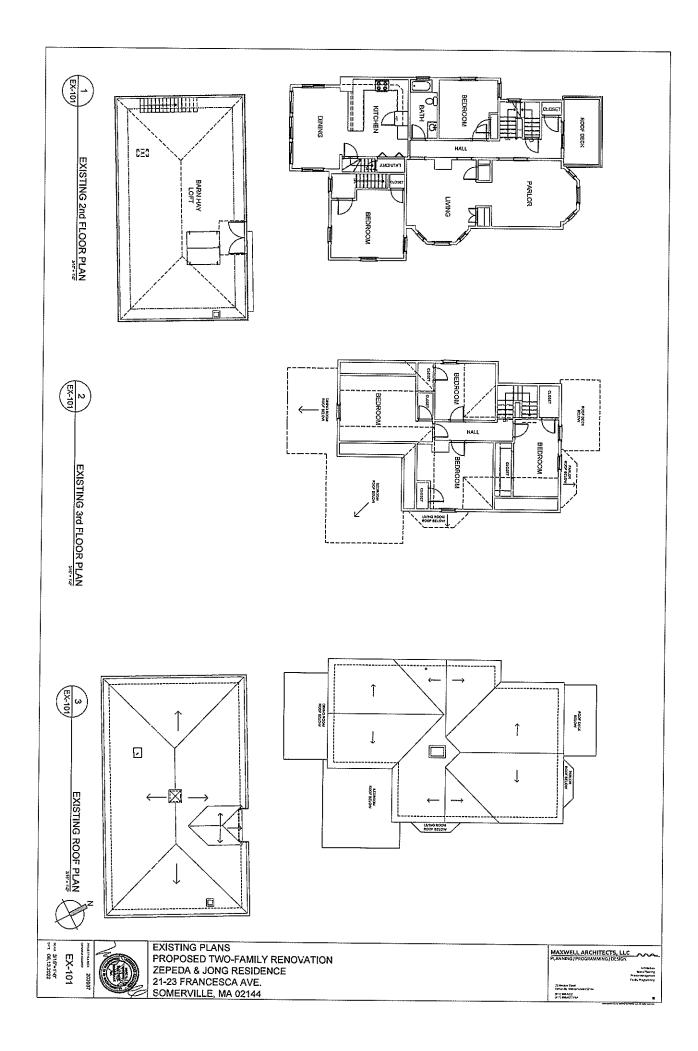

BACKYARD COTTAGE
EXISTING SIDE (WEST) ELEVATION

EX-202

